1-3 Dawson Street


New Plymouth

ISSUED FOR:


RESOURCE CONSENT

6592



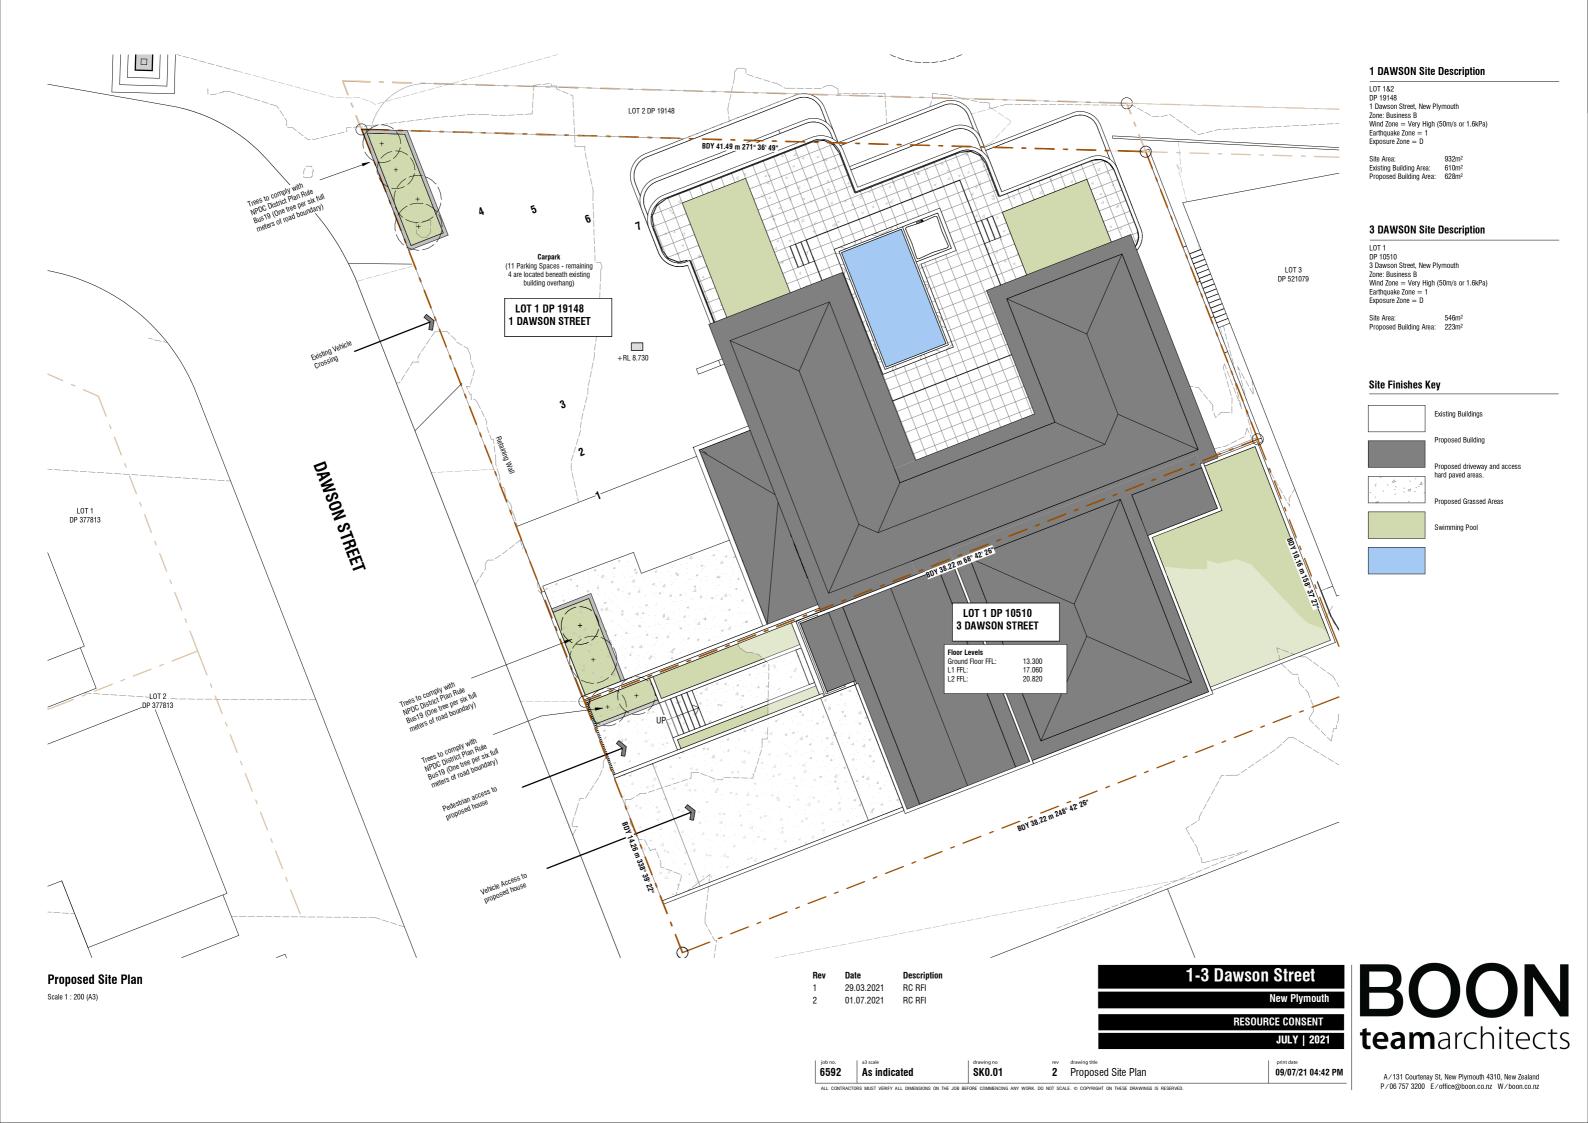



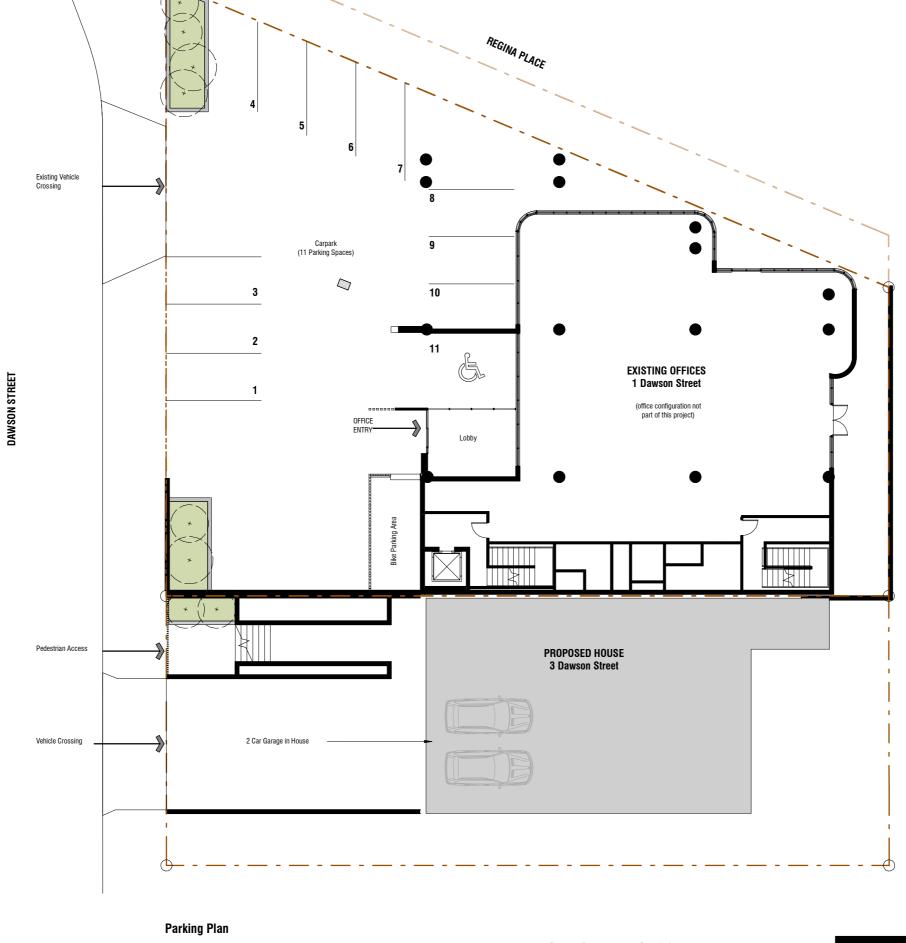

Scale 1 : 200 (A3)

 Rev
 Date
 Description

 1
 29.03.2021
 RC RFI

 2
 01.07.2021
 RC RFI

1-3 Dawson Street

New Plymouth


RESOURCE CONSENT

JULY | 2021

| job no. | a3 scale | drawing no | rev | drawing title | print date |

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3 Dawson Ground Floor

Scale 1: 200 (A3)

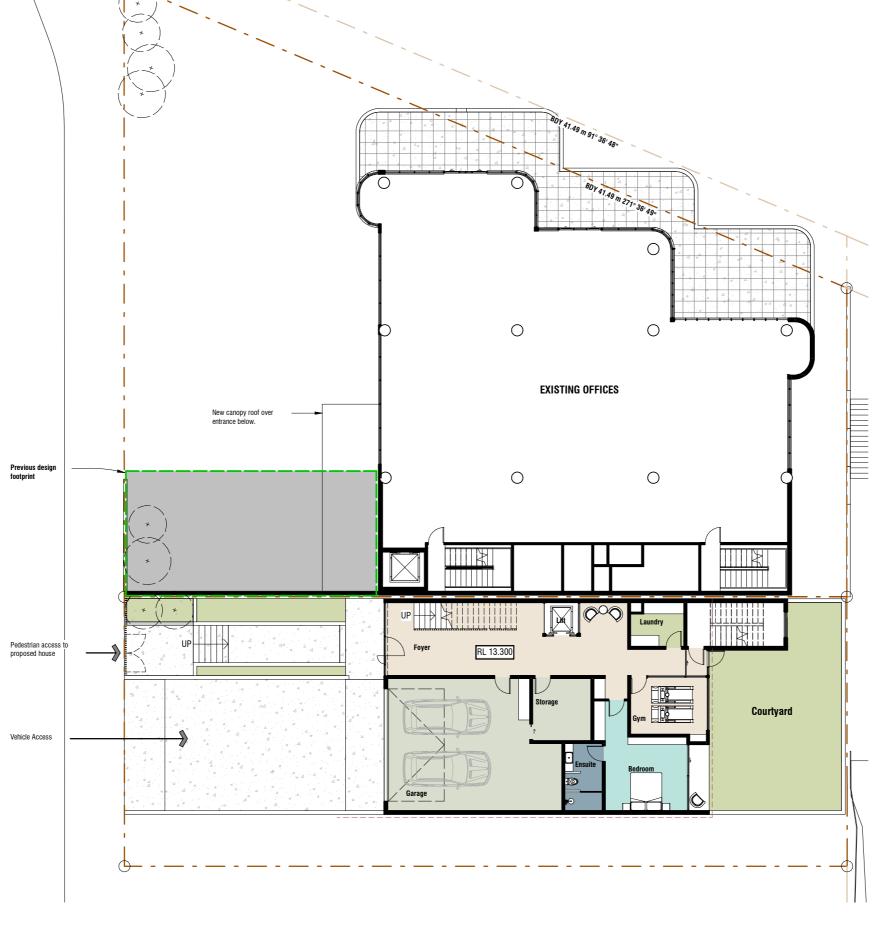DAWSON STREET

 Rev
 Date
 Description

 1
 29.03.2021
 RC RFI

 2
 01.07.2021
 RC RFI

1-3 Dawson Street

New Plymouth

RESOURCE CONSENT

RESOURCE CONSENT

JULY | 2021

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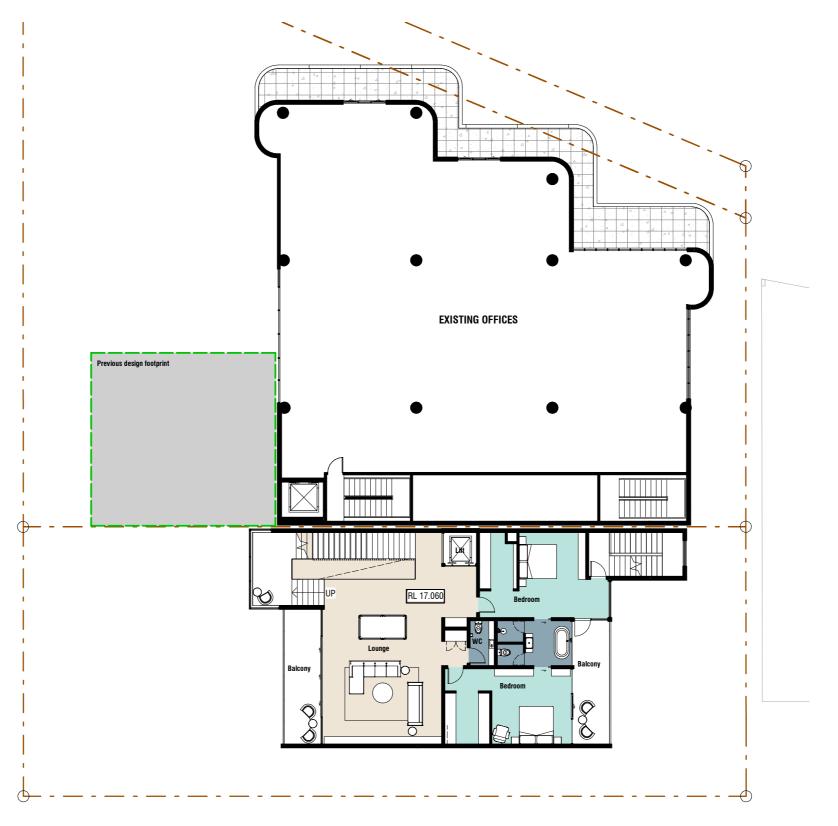




Previous Proposed Design Building Footprint Resource Consent: LUC20/47660

Existing Building 1 Dawson Street Proposed Building 1-3 Dawson Street

Resource Consent Key



Rev Date

01.07.2021

Description

RC RFI

3 Dawson Proposed Level 1 Plan

Scale 1 : 200 (A3)



1-3 Dawson Street






Previous Proposed Design Building Footprint Resource Consent: LUC20/47660

Existing Building 1 Dawson Street Proposed Building 1-3 Dawson Street

Resource Consent Key

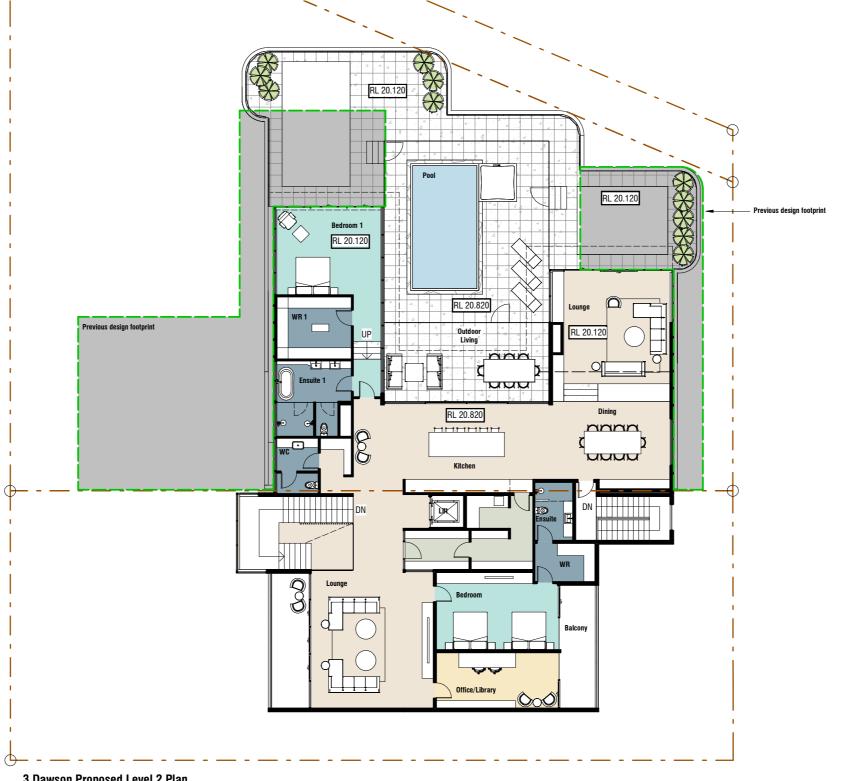

3 Dawson Proposed Level 2 Plan


Scale 1 : 200 (A3)

Rev Date Description 01.07.2021 RC RFI

1-3 Dawson Street RESOURCE CONSENT JULY | 2021

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job no. a3 scale 1:200 SK2.04 1 3 Dawson Proposed Level 2 09/07/21 04:42 PM

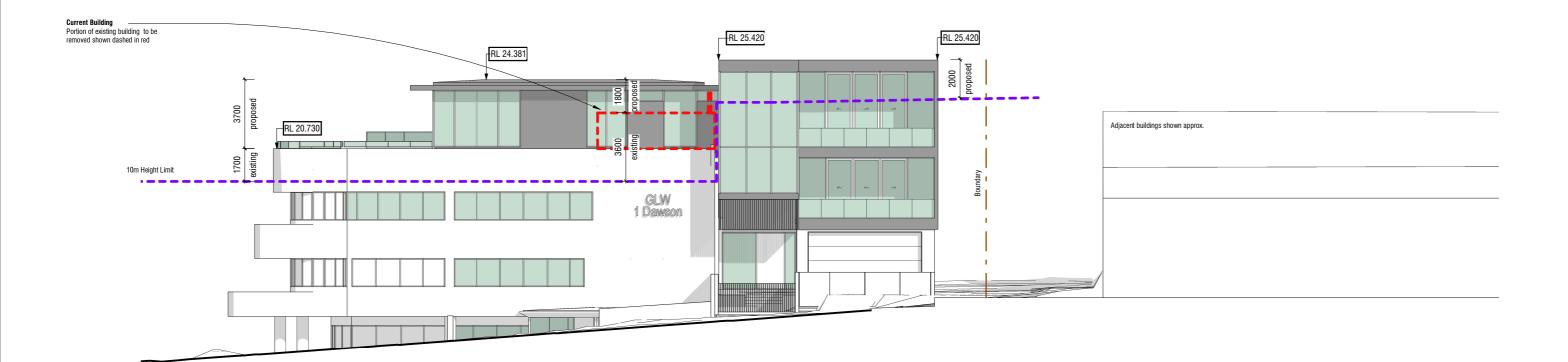


Proposed West Elevation - Proposed Only

Scale 1 : 200 (A3)





ALL CONTRACTORS MUST VERIFY ALL DIMENSIONS ON THE JOB BEFORE COMMENCING ANY WORK, DO NOT SCALE, © COPYRIGHT ON THESE DRAWINGS IS RESERVE

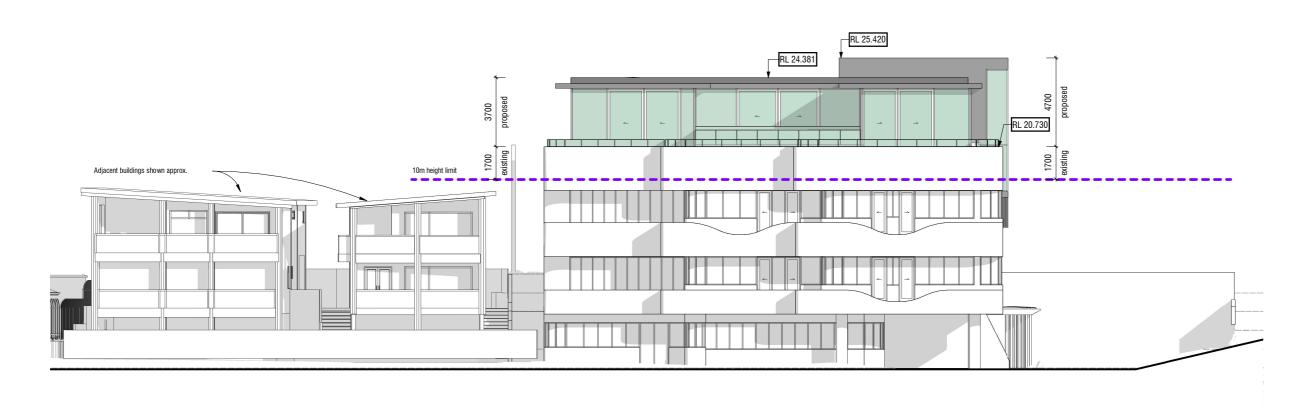

Proposed North Elevation - Proposed Only


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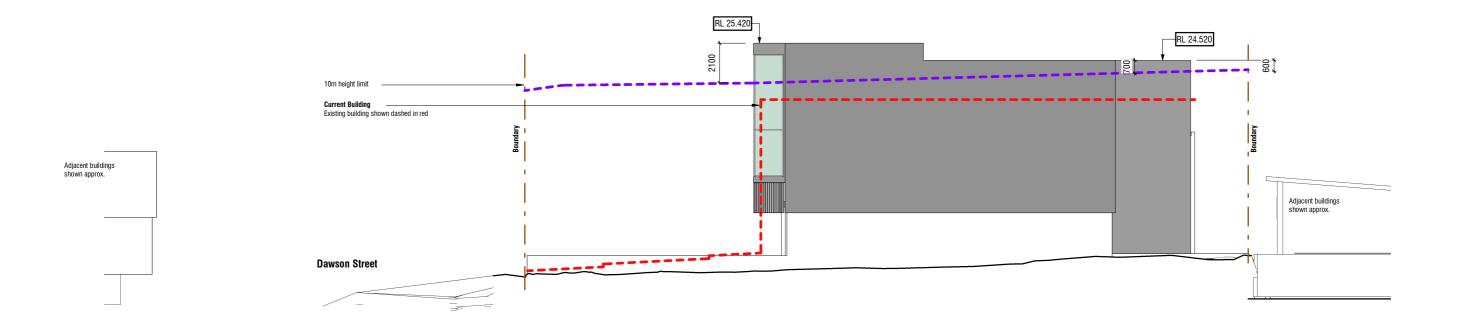


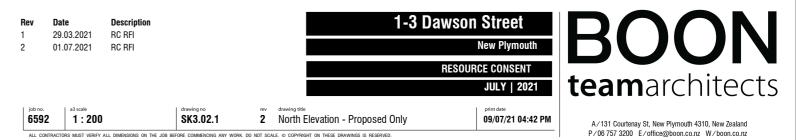

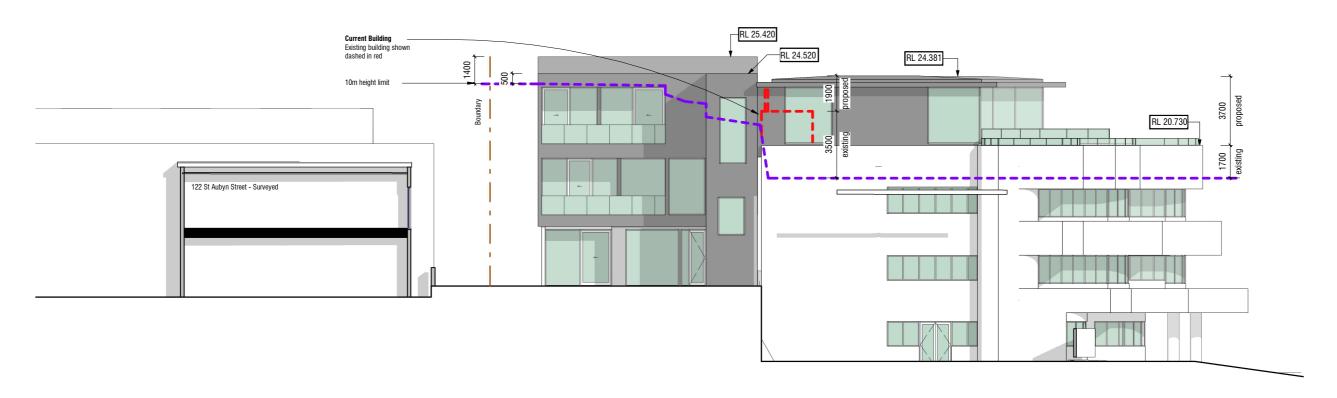Proposed East Elevation - Proposed Only


Scale 1: 200 (A3)



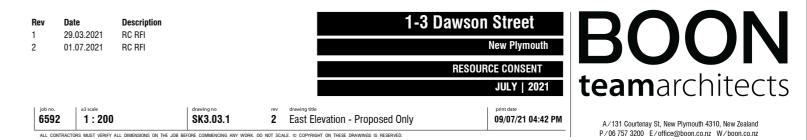

Proposed South Elevation - Proposed Only

Scale 1 : 200 (A3)

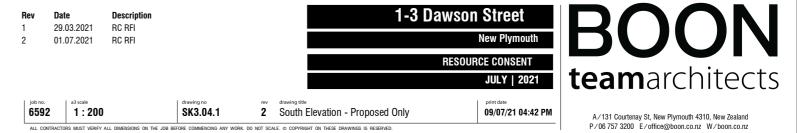



1-3 Dawson Street

Dawson Street Elevation


Scale1: 300 (A3)



job no. a3 scale 1: 300 rev drawing title

1 Dawson Street Elevation SK3.05 I SIONS ON THE JOB BEFORE COMMENCING ANY WORK. DO NOT SCALE. © COPYRIGHT ON THESE DRAWINGS IS RESERVED.

PERMITTED BASELINE BUILDING - DESIGN PROPOSAL PLAN EXTENTS

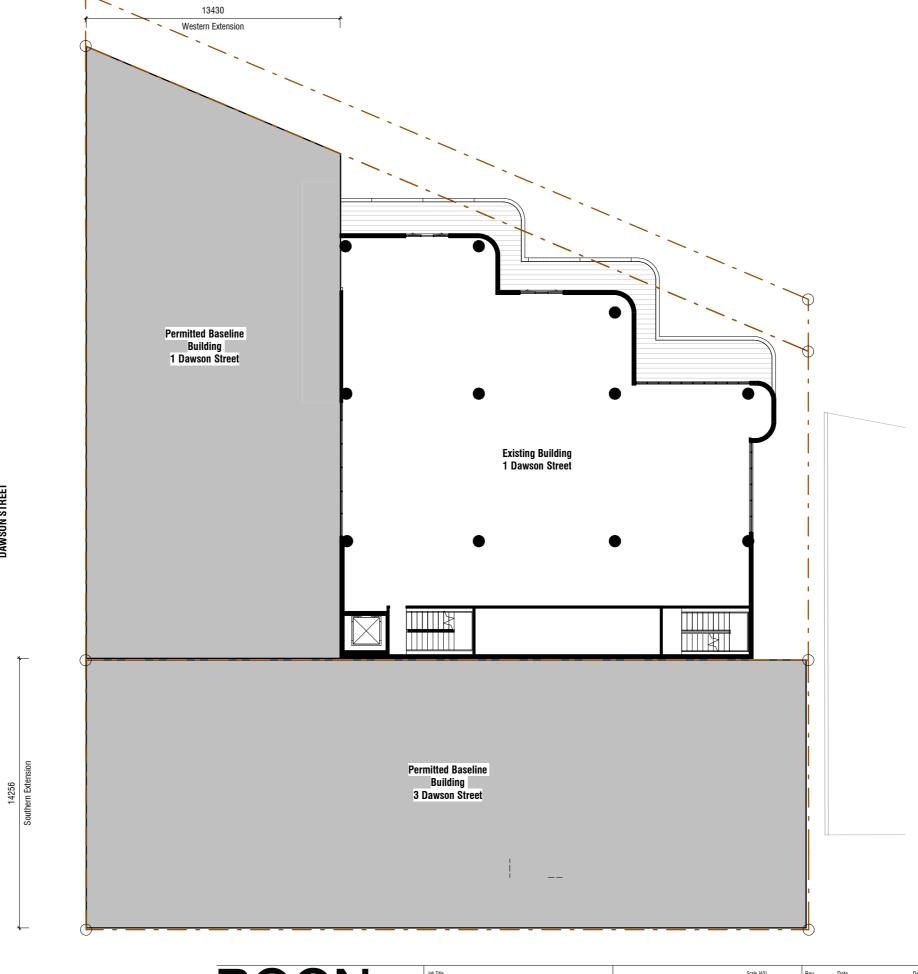

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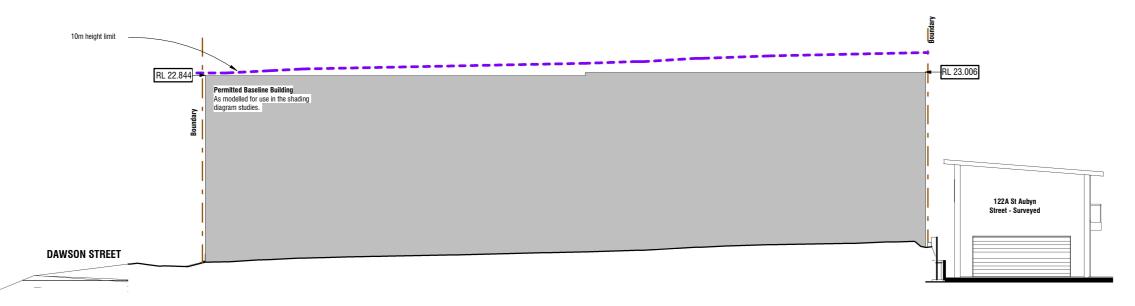
Scale [A3] 1:200 Permitted Baseline Building -Plan

Issued for: RESOURCE CONSENT Print Date 09/07/21 04:43 PM 6592 SK3.10



Permitted Baseline Building - West Elevation


Scale 1 : 200 (A3)



Permitted Baseline Building - South Elevation


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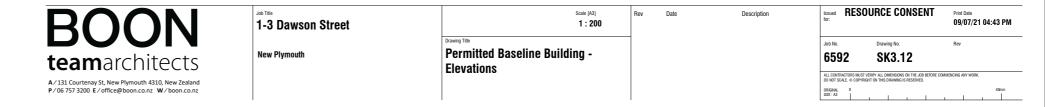


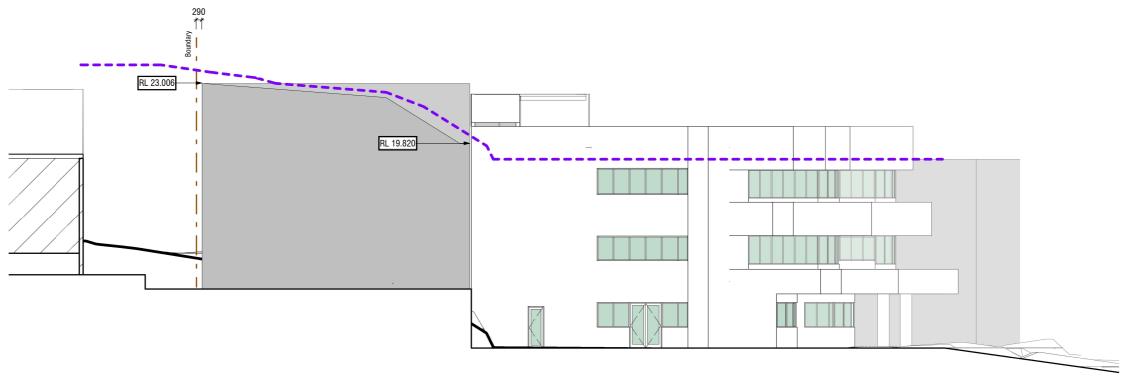


Permitted Baseline Building - East Elevation

Scale 1 : 200 (A3)



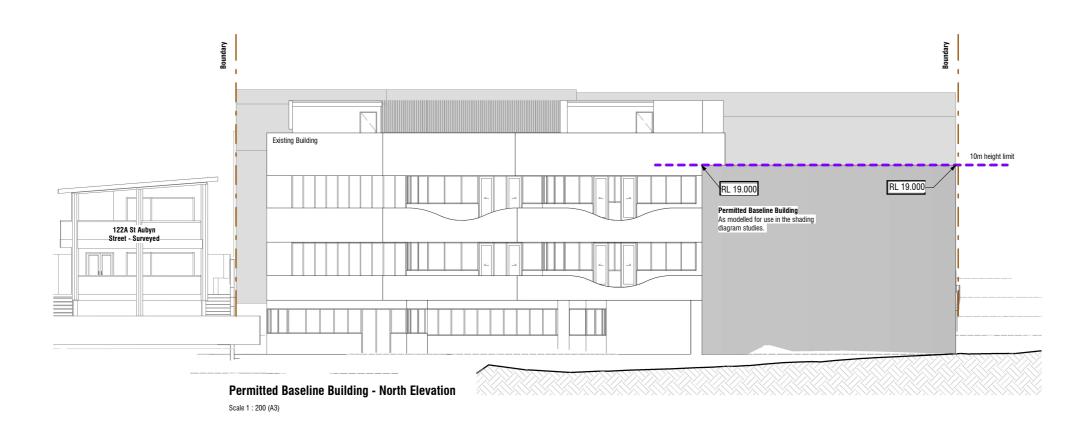

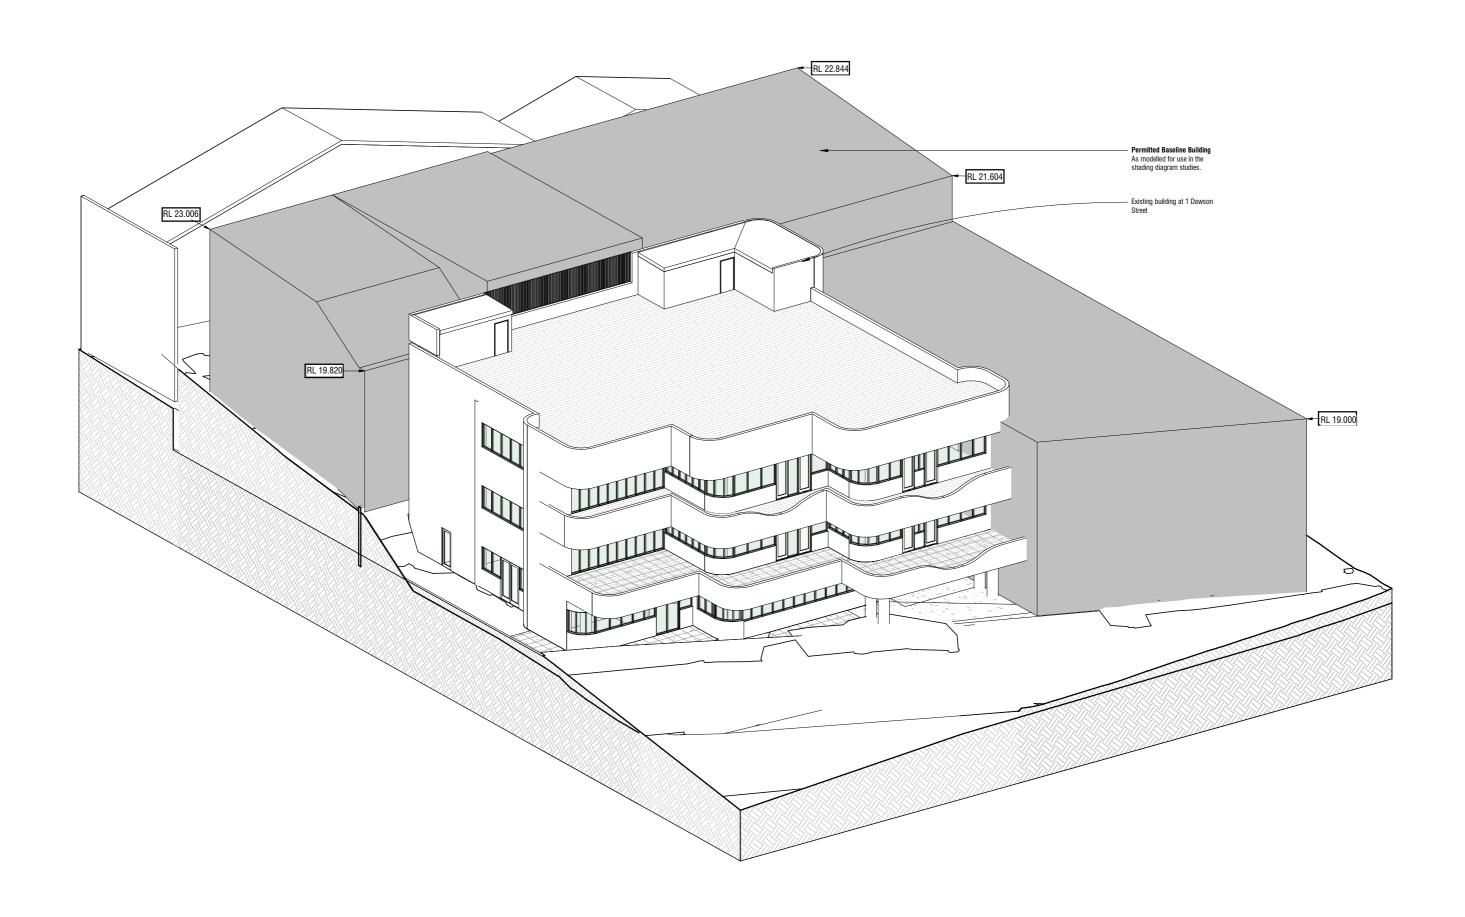

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1-3 Dawson Street
New Plymouth

	Scale [A3]	Rev	Date	Description	Issued for: Print Date 09/07/21 04:43 PM							04:43 PM
	Permitted Baseline Building - 3D Diagram				_{Јов No.}	2	SK.	g No. 3.1	3		Rev	
	ob blugium					CTORS MUST VEF LE. © COPYRIGHT				FORE COMM	ENCING ANY WORK.	40mm



Photo Taken from roof of 1 Dawson Street July 09 2020 - 4.34pm



Exising Shadows - July 09 4.34pm Scale (A3)

NB: ALL EXISTING NEIGHBOURING BUILDINGS IN RICHMOND ESTATE HAVE BEEN SURVEYED BY BTW LTD. AS NOTED

ALL SHADOWS SHOWN ARE DERIVED FROM REVIT SOFTWARE

 Rev
 Date
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 1
 01.07.2021
 RC RFI

job no. 6592 1-3 Dawson Street
New Plymouth
RESOURCE CONSENT
JULY | 2021

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a3 scale | drawing no rev drawing title | SK4.00 | 1 Shadow Study Check View - July 09 | 15/07/21 03:52 PM

MARCH (Sunrise at 7.30am)

SUNRISE SHADOW STUDY - 21 MARCH

- 9.00AM
- 10.00AM
- 11.00AM

(Sunrise at 7.30am)

21 MARCH - 9.00AM



Shadow Study - March 9am

Scale 1:500 (A3)

Date Rev Description 29.03.2021 RC RFI 01.07.2021 RC RFI 28.07.2021 RC RFI

1-3 Dawson Street
New Plymouth

RESOURCE CONSENT JULY | 2021


print date 28/07/21 01:27 PM 6592 As indicated SK4.01 3 Shadow Study - March 9.00am


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Shading Diagrams Key







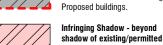

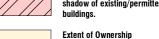1-3 Dawson St. Affect of shadows not considered within the boundaries of the applicants boundary

Surveyed buildings as noted.

Where buildings have not been surveyed, they have been modelled as near as practicable to provide a

Shadows are created using Revit 2022 Software. The site is located using Revit's inbuilt data to 1 Dawson Street New Plymouth.

(Sunrise at 7.30am)

21 MARCH - 10.00AM



Shadow Study - March 10am

Scale 1 : 500 (A3)

Date Description 29.03.2021 RC RFI 01.07.2021 RC RFI 28.07.2021 RC RFI

6592 As indicated

RESOURCE CONSENT JULY | 2021

3 Shadow Study - March 10.00am

28/07/21 01:27 PM

Shadow of a 'Permitted Building' Compliant under NPDC Operative District Plan:

Site Boundaries

Existing Buildings

Proposed Building

Existing Shadows

Shading Diagrams Key

Hatched area includes Existing and Proposed buildings.

Shadow of Proposed Development



Infringing Shadow - beyond shadow of existing/permitted



Extent of Ownership 1-3 Dawson St.

Affect of shadows not considered within the boundaries of the applicants boundary

Surveyed buildings as noted.

Where buildings have not been surveyed, they have been modelled as near as practicable to provide a

Shadows are created using Revit 2022 Software. The site is located using Revit's inbuilt data to 1 Dawson Street New Plymouth.



SK4.02

(Sunrise at 7.30am)

21 MARCH - 11.00AM



Shadow Study - March 11am

Scale 1:500 (A3)

Date Description 29.03.2021 RC RFI 01.07.2021 RC RFI 28.07.2021 RC RFI

6592 As indicated


1-3 Dawson Street
New Plymouth RESOURCE CONSENT JULY | 2021

3 Shadow Study - March 11.00am

28/07/21 01:27 PM

Shading Diagrams Key



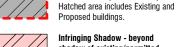

Infringing Shadow - beyond shadow of existing/permitted



Extent of Ownership 1-3 Dawson St. Affect of shadows not considered

within the boundaries of the applicants boundary

Surveyed buildings as noted.

Where buildings have not been surveyed, they have been modelled as near as practicable to provide a

Shadows are created using Revit 2022 Software. The site is located using Revit's inbuilt data to 1 Dawson Street New Plymouth.

SK4.03



SUNRISE SHADOW STUDY - 21 JUNE

- 8.00AM
- 9.00AM
- 10.00AM

SHADOW STUDY - JUNE

(Sunrise at 7.45am)

21 JUNE - 8.00AM



 Rev
 Date
 Description

 1
 29.03.2021
 RC RFI

 2
 01.07.2021
 RC RFI



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Shading Diagrams Key

Site Boundaries

Existing Buildings

Proposed Building

Existing Shadows

District Plan:

Shadow of a 'Permitted Building' Compliant under NPDC Operative

10m high

Shadow of Proposed Development
Hatched area includes Existing and

Infringing Shadow - beyond shadow of existing/permitted

Affect of shadows not considered

within the boundaries of the

Proposed buildings.

Extent of Ownership 1-3 Dawson St.

applicants boundary

Where buildings have not been surveyed, they have been modelled as near as practicable to provide a

Shadows are created using Revit 2022 Software. The site is located using Revit's inbuilt data to 1 Dawson Street New Plymouth.

Surveyed buildings as noted.

| ob no. | a3 scale | As indicated | drawing no | SK4.04 | Sk4.04 | Shadow Study - June 8.00am | print date | 15/07/21 03:52 PM

SHADOW STUDY - JUNE

(Sunrise at 7.45am)

21 JUNE - 9.00AM



Shadow Study - June 9am

Scale 1:500 (A3)

Date Rev Description RC RFI 29.03.2021 01.07.2021



15/07/21 03:53 PM

6592 As indicated SK4.05 2 Shadow Study - June 9.00am



Site Boundaries Existing Buildings Proposed Building Existing Shadows Shadow of a 'Permitted Building' Compliant under NPDC Operative District Plan:

Shadow of Proposed Development Hatched area includes Existing and Proposed buildings.

Infringing Shadow - beyond shadow of existing/permitted



Extent of Ownership 1-3 Dawson St. Affect of shadows not considered within the boundaries of the

applicants boundary

Surveyed buildings as noted. Where buildings have not been surveyed, they have been modelled as near as practicable to provide a

Shadows are created using Revit 2022 Software. The site is located using Revit's inbuilt data to 1 Dawson Street New Plymouth.

SHADOW STUDY - JUNE

(Sunrise at 7.45am)

21 JUNE - 10.00AM



Shadow Study - June 10am

Scale 1:500 (A3)

Date Rev Description 29.03.2021 RC RFI 01.07.2021

6592 As indicated

1-3 Dawson Street
New Plymouth **RESOURCE CONSENT** JULY | 2021

15/07/21 03:53 PM

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Shading Diagrams Key

Site Boundaries

Existing Buildings

Proposed Building

Existing Shadows

District Plan:

Proposed buildings.

Extent of Ownership 1-3 Dawson St.

applicants boundary

Where buildings have not been surveyed, they have been modelled as near as practicable to provide a

Shadows are created using Revit 2022 Software. The site is located using Revit's inbuilt data to 1 Dawson Street New Plymouth.

Surveyed buildings as noted.

Shadow of a 'Permitted Building' Compliant under NPDC Operative

Shadow of Proposed Development Hatched area includes Existing and

Infringing Shadow - beyond shadow of existing/permitted

Affect of shadows not considered

within the boundaries of the

SK4.06 2 Shadow Study - June 10.00am

SEPTEMBER

(Sunrise at 6.15am)

SUNRISE SHADOW STUDY - 21 SEPTEMBER

- 7.00AM
- 8.00AM
- 9.00AM

SHADOW STUDY - SEPTEMBER

(Sunrise at 6.15am)

21 SEPTEMBER - 7.00AM



Shadow Study - Sept 7am

Scale 1:500 (A3)

 Rev
 Date
 Description

 1
 29.03.2021
 RC RFI

 2
 01.07.2021
 RC RFI

1-3 Dawson Street

New Plymouth

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New Plymouth
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JULY | 2021

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Shading Diagrams Key

Site Boundaries

Existing Buildings

Proposed Building

Existing Shadows

District Plan:

Proposed buildings.

Extent of Ownership 1-3 Dawson St.

applicants boundary

Where buildings have not been surveyed, they have been modelled as near as practicable to provide a

Shadows are created using Revit 2022 Software. The site is located using Revit's inbuilt data to 1 Dawson Street New Plymouth.

Surveyed buildings as noted.

Shadow of a 'Permitted Building' Compliant under NPDC Operative

Shadow of Proposed Development Hatched area includes Existing and

Infringing Shadow - beyond shadow of existing/permitted

Affect of shadows not considered

within the boundaries of the

6592 As indicated SK4.07 2 Shadow Study - September 7.00am

print date 15/07/21 03:53 PM

SHADOW STUDY - SEPTEMBER

(Sunrise at 6.15am)

21 SEPTEMBER - 8.00AM



Date Rev Description 29.03.2021 RC RFI 01.07.2021



15/07/21 03:53 PM

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Shading Diagrams Key

Site Boundaries

Existing Buildings

Proposed Building

Existing Shadows

District Plan:

Proposed buildings.

Extent of Ownership 1-3 Dawson St.

applicants boundary

Where buildings have not been surveyed, they have been modelled as near as practicable to provide a

Shadows are created using Revit 2022 Software. The site is located using Revit's inbuilt data to 1 Dawson Street New Plymouth.

Surveyed buildings as noted.

Shadow of a 'Permitted Building' Compliant under NPDC Operative

Shadow of Proposed Development Hatched area includes Existing and

Infringing Shadow - beyond shadow of existing/permitted

Affect of shadows not considered


within the boundaries of the

6592 As indicated SK4.08 2 Shadow Study - September 8.00am

SHADOW STUDY - SEPTEMBER

(Sunrise at 6.15am)

21 SEPTEMBER - 9.00AM

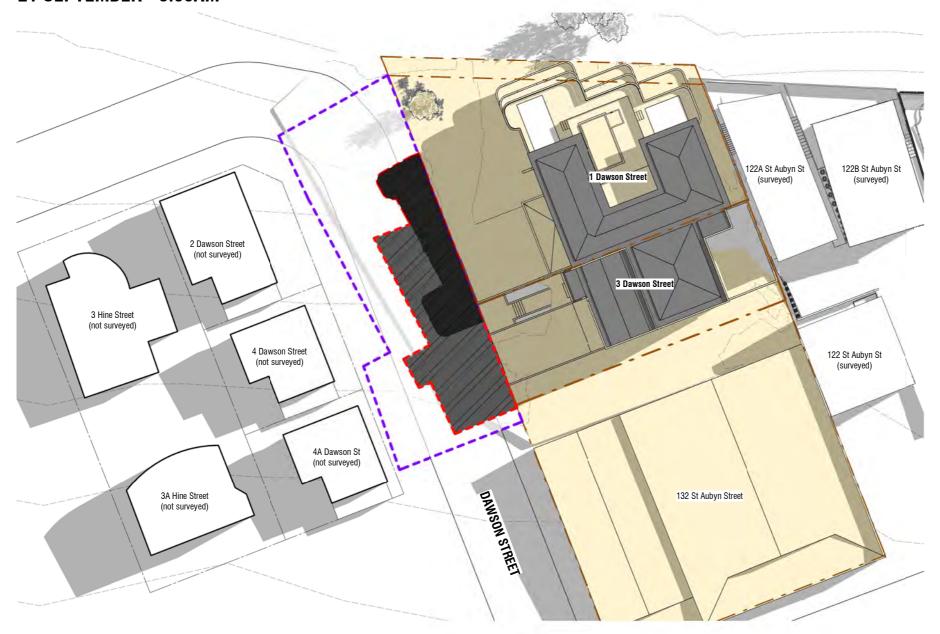

Shadow Study - Sept 9am

Scale 1 : 500 (A3)

 Rev
 Date
 Description

 1
 29.03.2021
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 01.07.2021
 RC RFI



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6592 As indicated SK4.09 2 Shadow Study - September 9.00am

15/07/21 03:53 PM

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Shading Diagrams Key

Site Boundaries

____ Existing Buildings

Proposed Building

Existing Shadows

Shadow of a 'Permitted Building'
Compliant under NPDC Operative

District Plan:

10m high



Shadow of Proposed Development
Hatched area includes Existing and
Proposed buildings.



Infringing Shadow - beyond shadow of existing/permitted buildings.



Extent of Ownership 1-3 Dawson St.

Affect of shadows not considered within the boundaries of the applicants boundary

Surveyed buildings as noted.

Where buildings have not been surveyed, they have been modelled as near as practicable to provide a visible net-effect of shading.

Shadows are created using Revit 2022 Software. The site is located using Revit's inbuilt data to 1 Dawson Street New Plymouth.

DECEMBER

(Sunrise at 5.55am)


SUNRISE SHADOW STUDY - 21 DECEMBER

- 8.00AM
- 9.00AM
- 10.00AM

SHADOW STUDY - DECEMBER

(Sunrise at 5.55am)

21 DECEMBER - 8.00AM

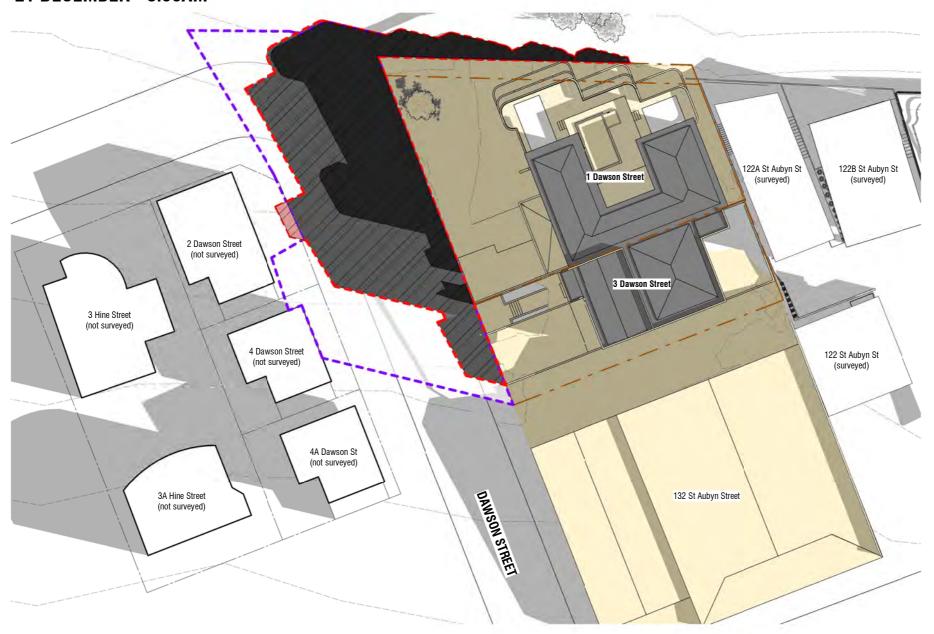

Shadow Study - Dec 8am

Scale 1:500 (A3)

Date Description 29.03.2021 RC RFI 01.07.2021 RC RFI 28.07.2021 RC RFI


1-3 Dawson Street
New Plymouth RESOURCE CONSENT

JULY | 2021

6592 As indicated SK4.10 3 Shadow Study - December 8.00am

28/07/21 01:28 PM

Shading Diagrams Key

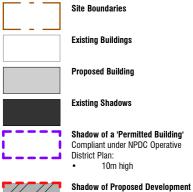



Infringing Shadow - beyond shadow of existing/permitted



Extent of Ownership 1-3 Dawson St. Affect of shadows not considered within the boundaries of the

applicants boundary

Surveyed buildings as noted.


Where buildings have not been surveyed, they have been modelled as near as practicable to provide a

Shadows are created using Revit 2022 Software. The site is located using Revit's inbuilt data to 1 Dawson Street New Plymouth.

SHADOW STUDY - DECEMBER

(Sunrise at 5.55am)

21 DECEMBER - 9.00AM

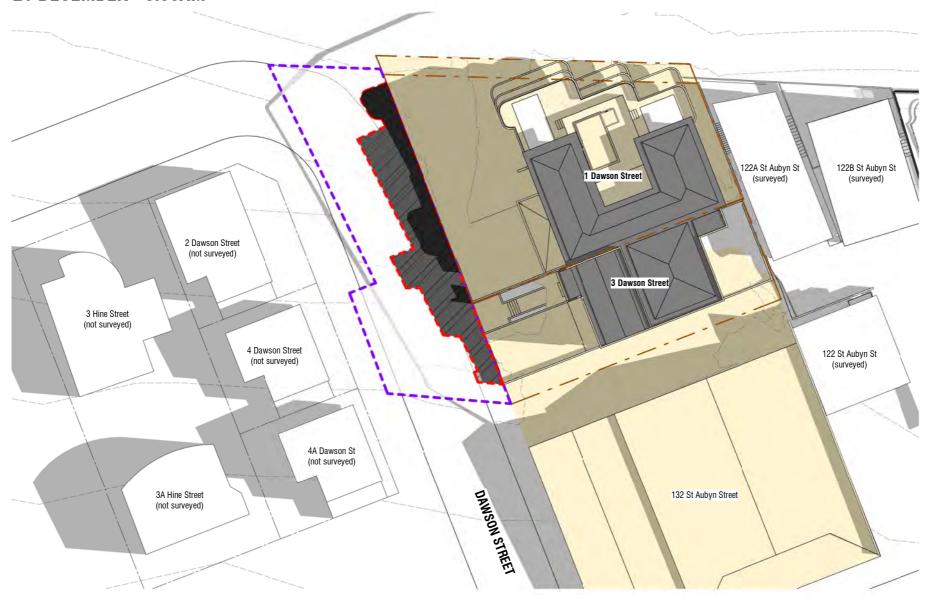

Shadow Study - Dec 9am

Scale 1:500 (A3)

Date Rev Description 29.03.2021 RC RFI 01.07.2021 RC RFI 28.07.2021 RC RFI

6592 As indicated

1-3 Dawson Street
New Plymouth

3 Shadow Study - December 9.00am

JULY | 2021

28/07/21 01:28 PM

Site Boundaries

Shading Diagrams Key

Existing Buildings Proposed Building

Existing Shadows

Shadow of a 'Permitted Building' Compliant under NPDC Operative

District Plan:



Shadow of Proposed Development Hatched area includes Existing and Proposed buildings.



Infringing Shadow - beyond shadow of existing/permitted



Extent of Ownership 1-3 Dawson St.

Affect of shadows not considered within the boundaries of the applicants boundary

Surveyed buildings as noted.

Where buildings have not been surveyed, they have been modelled as near as practicable to provide a


Shadows are created using Revit 2022 Software. The site is located using Revit's inbuilt data to 1 Dawson Street New Plymouth.

SK4.11

SHADOW STUDY - DECEMBER

(Sunrise at 5.55am)

21 DECEMBER - 10.00AM

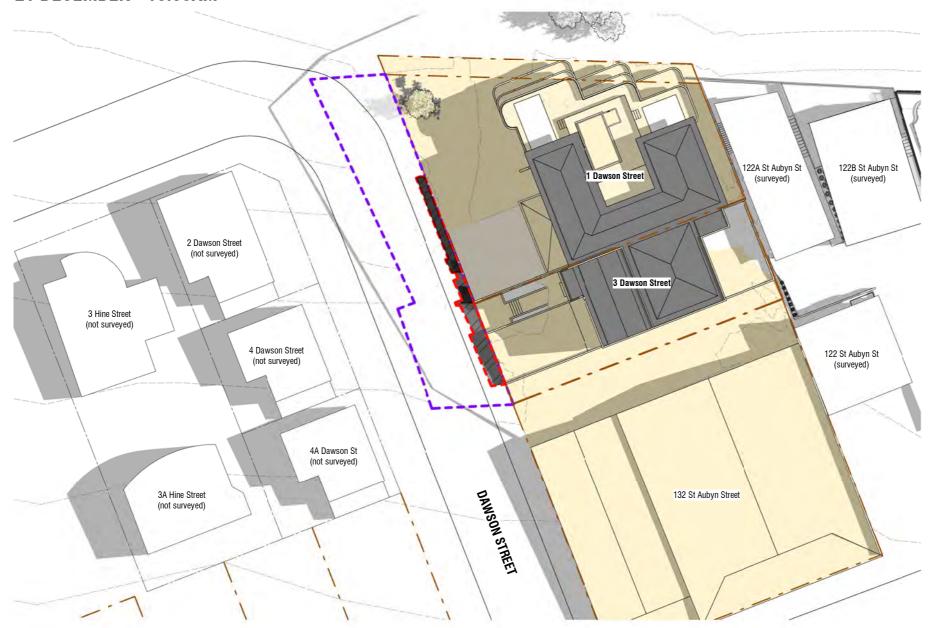

Shadow Study - Dec 10am

Scale 1:500 (A3)

Date Description 29.03.2021 RC RFI 01.07.2021 RC RFI 28.07.2021 RC RFI

6592 As indicated


1-3 Dawson Street
New Plymouth

RESOURCE CONSENT JULY | 2021

SK4.12 3 Shadow Study - December 10.00am

28/07/21 01:28 PM

Shading Diagrams Key

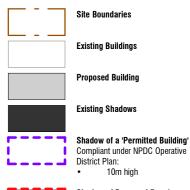



Shadow of Proposed Development Hatched area includes Existing and Proposed buildings.



Infringing Shadow - beyond shadow of existing/permitted



Extent of Ownership 1-3 Dawson St. Affect of shadows not considered within the boundaries of the

Surveyed buildings as noted. Where buildings have not been surveyed, they have been modelled as near as practicable to provide a

applicants boundary

Shadows are created using Revit 2022 Software. The site is located using Revit's inbuilt data to 1 Dawson Street New Plymouth.



MARCH (Sunset at 7.30pm)

SUNSET SHADOW STUDY - 21 MARCH

- 6.00PM
- 7.00PM

(Sunset at 7.30pm)

21 MARCH - 6.00PM



Shadow Study - March 6pm Scale 1:500 (A3)

Date Description 29.03.2021 RC RFI 01.07.2021 RC RFI RC RFI 28.07.2021

1-3 Dawson Street


RESOURCE CONSENT JULY | 2021

print date 28/07/21 01:28 PM

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6592 As indicated SK4.13 3 Shadow Study - March 6pm



Shading Diagrams Key

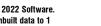Site Boundaries

Existing Buildings

Proposed Building

Existing Shadows

Shadow of a 'Permitted Building' Compliant under NPDC Operative District Plan:

10m high



Shadow of Proposed Development Hatched area includes Existing and Proposed buildings.



Infringing Shadow - beyond shadow of existing/permitted



Extent of Ownership 1-3 Dawson St.

Affect of shadows not considered within the boundaries of the applicants boundary

Surveyed buildings as noted.

Where buildings have not been surveyed, they have been modelled as near as practicable to provide a

Shadows are created using Revit 2022 Software. The site is located using Revit's inbuilt data to 1 Dawson Street New Plymouth.

(Sunset at 7.30pm)

21 MARCH - 7.00PM



Shadow Study - March 7pm Scale 1:500 (A3)

> Date Description 29.03.2021 RC RFI 01.07.2021 RC RFI 28.07.2021 RC RFI

6592 As indicated

1-3 Dawson Street

RESOURCE CONSENT JULY | 2021

print date 28/07/21 01:28 PM

Shading Diagrams Key

Site Boundaries Existing Buildings

Proposed Building

Existing Shadows Shadow of a 'Permitted Building'

Compliant under NPDC Operative District Plan: 10m high

Shadow of Proposed Development Hatched area includes Existing and Proposed buildings.



Infringing Shadow - beyond shadow of existing/permitted



Extent of Ownership 1-3 Dawson St.

Affect of shadows not considered within the boundaries of the applicants boundary

Surveyed buildings as noted.

Where buildings have not been surveyed, they have been modelled as near as practicable to provide a


Shadows are created using Revit 2022 Software. The site is located using Revit's inbuilt data to 1 Dawson Street New Plymouth.

3 Shadow Study - March 7pm

SK4.14

(Sunset at 7.30pm)

21 MARCH - 8.00PM

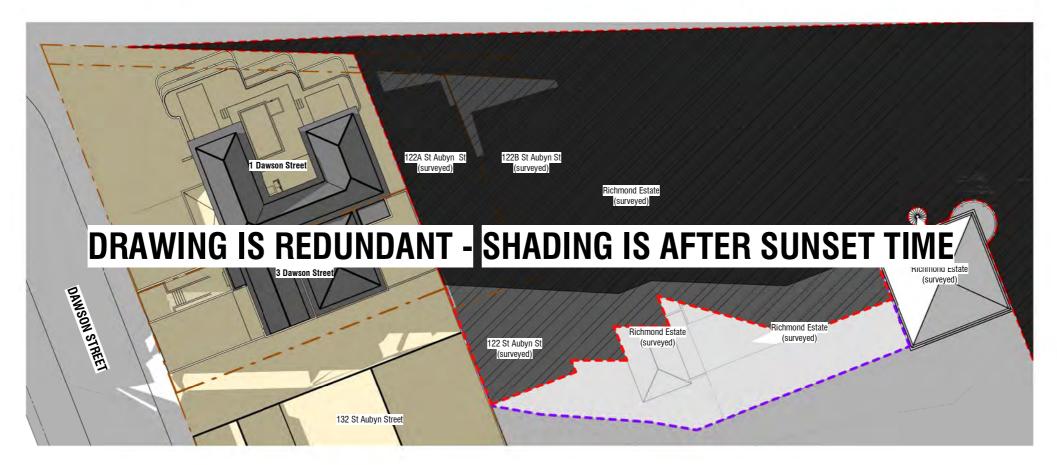

Shadow Study - March 8pm

Scale 1:500 (A3)

 Rev
 Date
 Description

 1
 29.03.2021
 RC RFI

 2
 01.07.2021
 RC RFI

 3
 28.07.2021
 RC RFI

1-3 Dawson Street

New Plymouth

RESOURCE CONSENT

JULY | 2021 print date 28/07/21 01:29 PM

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Shading Diagrams Key

Site Boundaries

Existing Buildings

Proposed Building

Existing Shadows

District Plan:

Proposed buildings.

Infringing Shadow - beyond shadow of existing/permitted

Extent of Ownership 1-3 Dawson St.

Where buildings have not been surveyed, they have been modelled as near as practicable to provide a

Shadows are created using Revit 2022 Software. The site is located using Revit's inbuilt data to 1

Surveyed buildings as noted.

Dawson Street New Plymouth.

Shadow of a 'Permitted Building' Compliant under NPDC Operative

Shadow of Proposed Development Hatched area includes Existing and

Affect of shadows not considered within the boundaries of the applicants boundary

| ob no. | a3 scale | As indicated | drawing no | SK4.15 | Shadow Study - March 8pm | print date 28/07/21




SUNSET SHADOW STUDY - 21 JUNE

- 3.00PM
- 4.00PM
- 5.00PM

SHADOW STUDY - JUNE

(Sunset at 5.10pm)

21 JUNE - 3.00PM

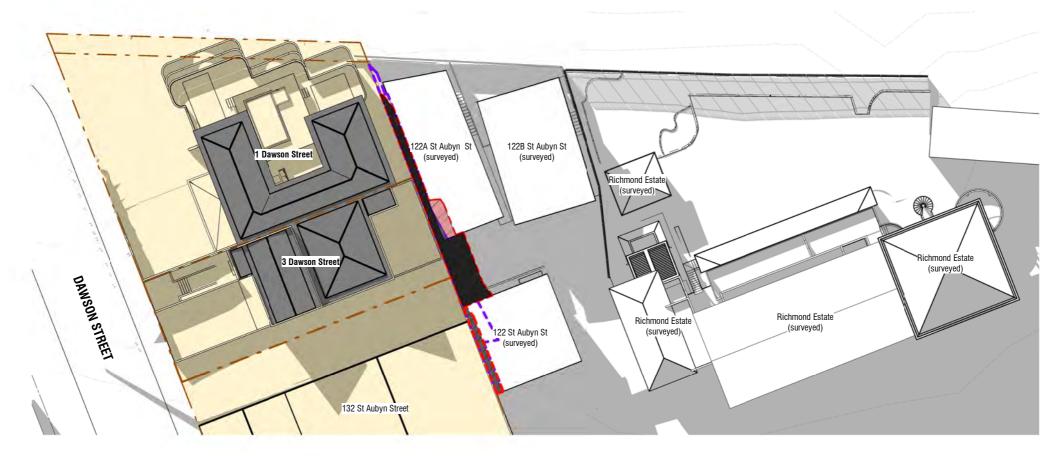

Shadow Study - June 3pm Scale 1 : 500 (A3)

 Rev
 Date
 Description

 1
 29.03.2021
 RC RFI

 2
 01.07.2021
 RC RFI

6592 As indicated

1-3 Dawson Street

New Plymouth

RESOURCE CONSENT

JULY | 2021

print date 15/07/21 03:54 PM N

Shading Diagrams Key



Proposed Building



Existing Shadows



Shadow of a 'Permitted Building' Compliant under NPDC Operative District Plan:



Shadow of Proposed Development
Hatched area includes Existing and
Proposed buildings.



Infringing Shadow - beyond shadow of existing/permitted



Extent of Ownership 1-3 Dawson St.

Affect of shadows not considered within the boundaries of the applicants boundary

Surveyed buildings as noted.

Where buildings have not been surveyed, they have been modelled as near as practicable to provide a visible net-effect of shading.

Shadows are created using Revit 2022 Software. The site is located using Revit's inbuilt data to 1 Dawson Street New Plymouth.

2 Shadow Study - June 3pm

SHADOW STUDY - JUNE

(Sunset at 5.10pm)

21 JUNE - 4.00PM



Shadow Study - June 4pm Scale 1:500 (A3)

Date Rev Description RC RFI 29.03.2021 01.07.2021

6592 As indicated



15/07/21 03:55 PM

A/131 Courtenay St, New Plymouth 4310, New Zealand P/06 757 3200 E/office@boon.co.nz W/boon.co.nz

2 Shadow Study - June 4pm

SK4.17



Shading Diagrams Key





Proposed Building



Existing Shadows



Shadow of a 'Permitted Building' Compliant under NPDC Operative





Shadow of Proposed Development Hatched area includes Existing and Proposed buildings.



Infringing Shadow - beyond shadow of existing/permitted



Extent of Ownership 1-3 Dawson St.

Affect of shadows not considered within the boundaries of the applicants boundary

Surveyed buildings as noted.


Where buildings have not been surveyed, they have been modelled as near as practicable to provide a

Shadows are created using Revit 2022 Software. The site is located using Revit's inbuilt data to 1 Dawson Street New Plymouth.

SHADOW STUDY - JUNE

(Sunset at 5.10pm)

21 JUNE - 5.00PM

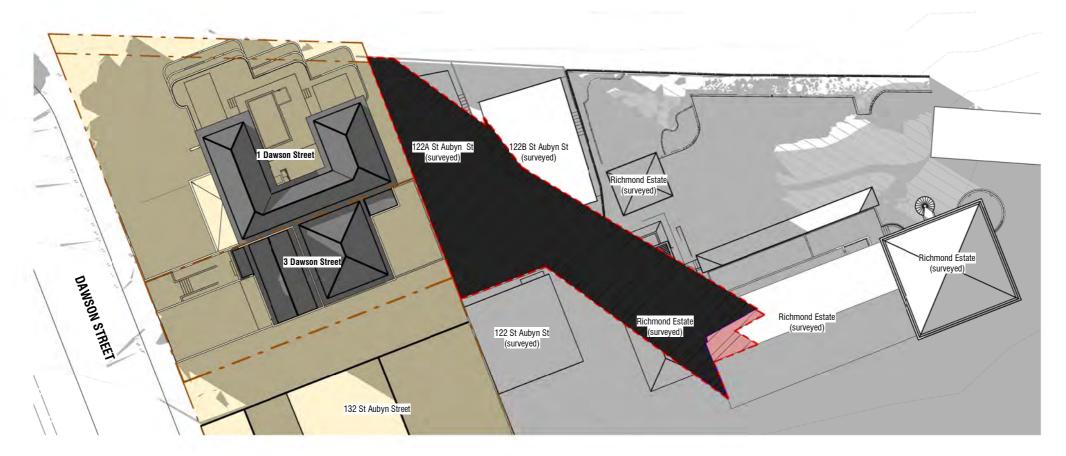

Shadow Study - June 5pm Scale 1 : 500 (A3)

 Rev
 Date
 Description

 1
 29.03.2021
 RC RFI

 2
 01.07.2021
 RC RFI



RESOURCE CONSENT JULY | 2021

rev drawing title
2 Shadow Study - June 5pm print date 15/07/21 03:55 PM

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6592 As indicated SK4.18 2 Shadow Study - June 5pm



Shading Diagrams Key



Existing Buildings



Proposed Building



Existing Shadows



Shadow of a 'Permitted Building' Compliant under NPDC Operative District Plan:





Shadow of Proposed Development Hatched area includes Existing and Proposed buildings.



Infringing Shadow - beyond shadow of existing/permitted



Extent of Ownership 1-3 Dawson St.

Affect of shadows not considered within the boundaries of the applicants boundary

Surveyed buildings as noted.

Where buildings have not been surveyed, they have been modelled as near as practicable to provide a visible net-effect of shading.

Shadows are created using Revit 2022 Software. The site is located using Revit's inbuilt data to 1 Dawson Street New Plymouth.

SEPTEMBER

(Sunset at 6.20pm)


SUNSET SHADOW STUDY - 21 SEPTEMBER

- 4.00PM
- 5.00PM
- 6.00PM

SHADOW STUDY - SEPTEMBER

(Sunset at 6.20pm)

21 SEPTEMBER - 4.00PM

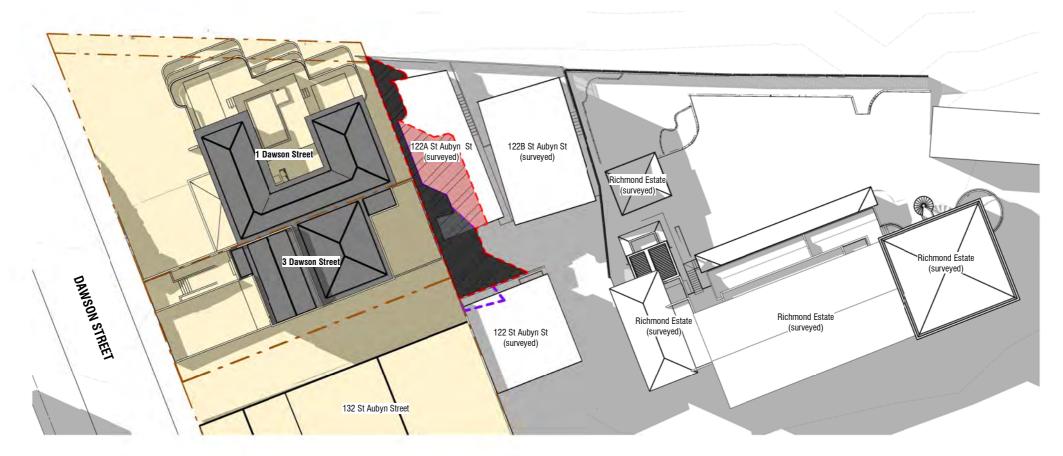

Shadow Study - Sept 4pm Scale 1:500 (A3)

Date Rev Description 29.03.2021 RC RFI 01.07.2021


6592 As indicated

1-3 Dawson Street **RESOURCE CONSENT** JULY | 2021

2 Shadow Study - September 4pm

15/07/21 03:55 PM

Shading Diagrams Key

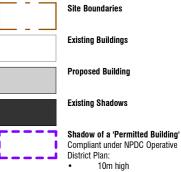



Shadow of Proposed Development Hatched area includes Existing and Proposed buildings.



Infringing Shadow - beyond shadow of existing/permitted



Extent of Ownership 1-3 Dawson St. Affect of shadows not considered

within the boundaries of the applicants boundary

Surveyed buildings as noted.


Where buildings have not been surveyed, they have been modelled as near as practicable to provide a

Shadows are created using Revit 2022 Software. The site is located using Revit's inbuilt data to 1 Dawson Street New Plymouth.

SHADOW STUDY - SEPTEMBER

(Sunset at 6.20pm)

21 SEPTEMBER - 5.00PM

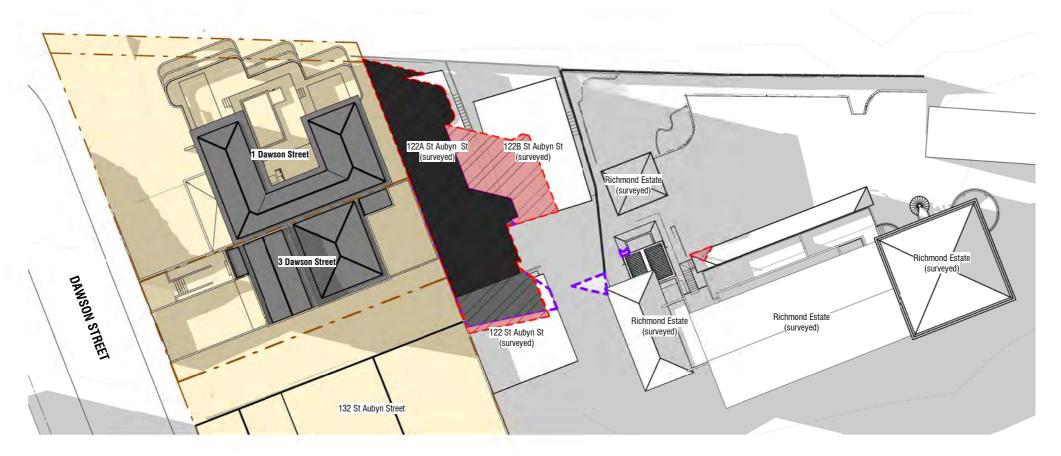

Shadow Study - Sept 5pm Scale 1: 500 (A3)





6592 As indicated





print date 15/07/21 03:55 PM N)

Shading Diagrams Key

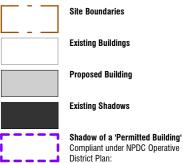

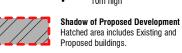

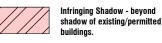

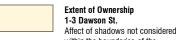

within the boundaries of the applicants boundary

Surveyed buildings as noted.

Where buildings have not been surveyed, they have been modelled as near as practicable to provide a visible net-effect of shading.

Shadows are created using Revit 2022 Software. The site is located using Revit's inbuilt data to 1 Dawson Street New Plymouth.

2 Shadow Study - September 5pm

SHADOW STUDY - SEPTEMBER

(Sunset at 6.20pm)

21 SEPTEMBER - 6.00PM



Shadow Study - Sept 6pm Scale 1:500 (A3)

> Date Rev Description 29.03.2021 RC RFI 01.07.2021


6592 As indicated




2 Shadow Study - September 6pm

15/07/21 03:55 PM

Shading Diagrams Key

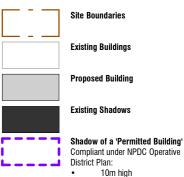

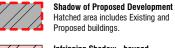

Infringing Shadow - beyond shadow of existing/permitted



Extent of Ownership 1-3 Dawson St.

Affect of shadows not considered within the boundaries of the applicants boundary

Surveyed buildings as noted.

Where buildings have not been surveyed, they have been modelled as near as practicable to provide a

Shadows are created using Revit 2022 Software. The site is located using Revit's inbuilt data to 1 Dawson Street New Plymouth.

DECEMBER

(Sunset at 8.50pm)


SUNSET SHADOW STUDY - 21 DECEMBER

- 7.00PM
- 8.00PM

SHADOW STUDY - DECEMBER


(Sunset at 8.50pm)

21 DECEMBER - 7.00PM

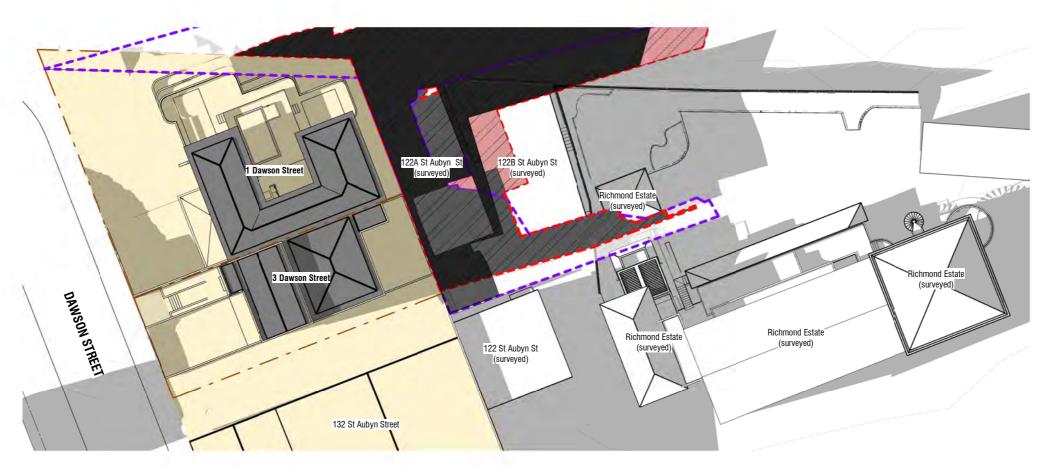

Shadow Study - Sunset Dec 7pm

Scale 1:500 (A3)

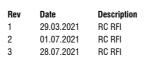

6592 As indicated



RESOURCE CONSENT JULY | 2021

3 Shadow Study - December 7pm

print date 28/07/21 01:29 PM

A/131 Courtenay St, New Plymouth 4310, New Zealand P/06 757 3200 E/office@boon.co.nz W/boon.co.nz

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Shading Diagrams Key

Site Boundaries

Existing Buildings

Proposed Building

Existing Shadows

District Plan:

Proposed buildings.

Extent of Ownership 1-3 Dawson St.

Where buildings have not been surveyed, they have been modelled as near as practicable to provide a

Shadows are created using Revit 2022 Software. The site is located using Revit's inbuilt data to 1 Dawson Street New Plymouth.

Surveyed buildings as noted.

Shadow of a 'Permitted Building' Compliant under NPDC Operative

Shadow of Proposed Development Hatched area includes Existing and


Infringing Shadow - beyond shadow of existing/permitted

Affect of shadows not considered within the boundaries of the applicants boundary

SHADOW STUDY - DECEMBER

(Sunset at 8.50pm)

21 DECEMBER - 8.00PM

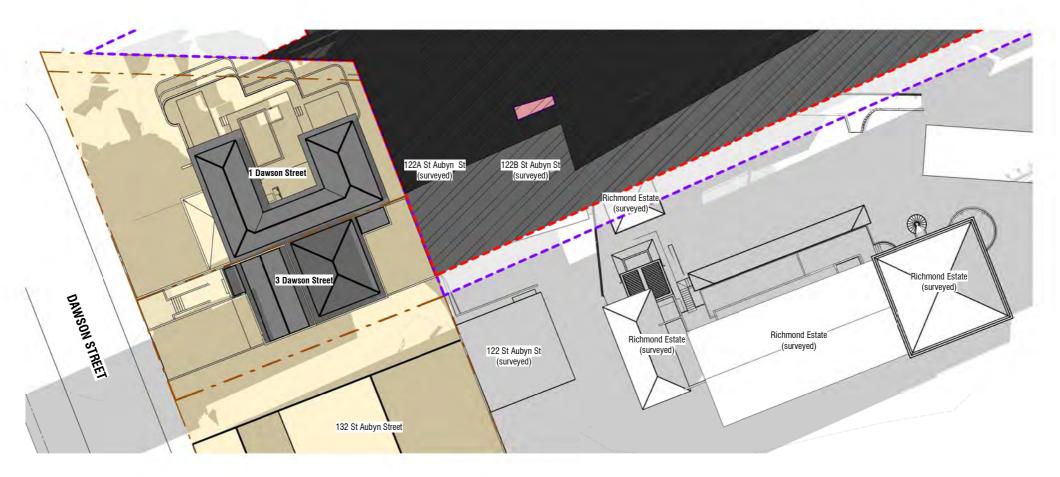

Shadow Study - Sunset Dec 8pm Scale 1:500 (A3)


Date Description 29.03.2021 RC RFI 01.07.2021 RC RFI 28.07.2021 RC RFI

1-3 Dawson Street

RESOURCE CONSENT JULY | 2021

print date 28/07/21 01:29 PM 6592 As indicated SK4.23 3 Shadow Study - December 8pm

Shading Diagrams Key

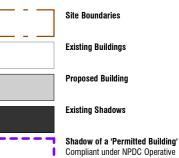

District Plan:



Shadow of Proposed Development Hatched area includes Existing and



Infringing Shadow - beyond shadow of existing/permitted



Extent of Ownership 1-3 Dawson St.

Affect of shadows not considered within the boundaries of the applicants boundary

Surveyed buildings as noted.


Where buildings have not been surveyed, they have been modelled as near as practicable to provide a

Shadows are created using Revit 2022 Software. The site is located using Revit's inbuilt data to 1 Dawson Street New Plymouth.

SHADOW STUDY - DECEMBER

(Sunset at 8.50pm)

21 DECEMBER - 9.00PM

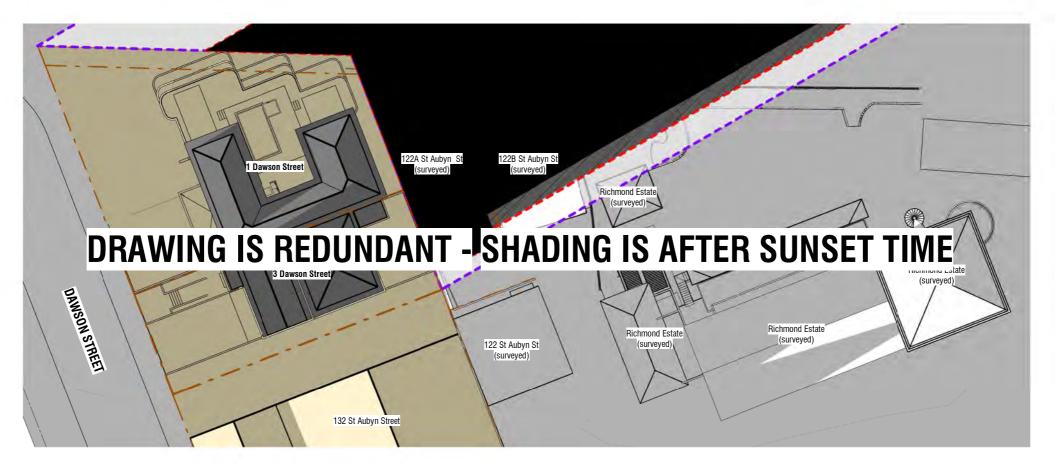

Shadow Study - Sunset Dec 9pm Scale 1:500 (A3)

> Date Description 29.03.2021 RC RFI 01.07.2021 RC RFI RC RFI 28.07.2021

1-3 Dawson Street RESOURCE CONSENT

> JULY | 2021 28/07/21 01:29 PM

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6592 As indicated SK4.24 3 Shadow Study - December 9pm

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Shading Diagrams Key

Site Boundaries **Existing Buildings**

Proposed Building

Existing Shadows

Shadow of a 'Permitted Building' Compliant under NPDC Operative District Plan:

Proposed buildings.

Shadow of Proposed Development Hatched area includes Existing and



Infringing Shadow - beyond shadow of existing/permitted




Extent of Ownership 1-3 Dawson St.

Affect of shadows not considered within the boundaries of the applicants boundary

Surveyed buildings as noted.

Where buildings have not been surveyed, they have been modelled as near as practicable to provide a

Shadows are created using Revit 2022 Software. The site is located using Revit's inbuilt data to 1 Dawson Street New Plymouth.

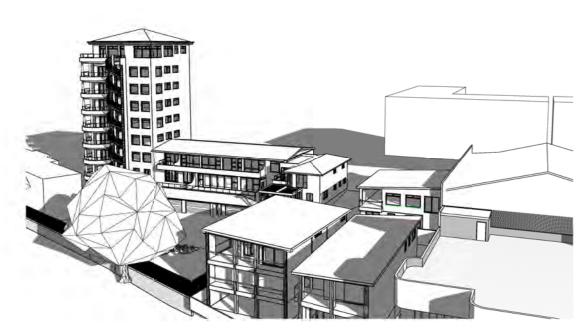

Sunset Shading - March Existing 6.00pm

Scale (A3)



Sunset Shading - March Proposed 6.00pm

BB 500 86 900 BB 808

Sunset Shading - March Existing 6.30pm

Scale (A3)



Sunset Shading - March Proposed 6.30pm

Proposed Sunset Shading Key

Shadow of a Permitted Development Overlap - Shadow of a Permitted Development AND Shadow of the Proposed Development

Additional shading created by shadow of the Proposed

Date Description 29.03.2021 RC RFI 01.07.2021 RC RFI RC RFI 28.07.2021

1-3 Dawson Street

RESOURCE CONSENT JULY | 2021

28/07/21 01:30 PM 6592 1:100 SK5.01 3 Sunset Shadow Studies - March

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A/131 Courtenay St, New Plymouth 4310, New Zealand P/06 757 3200 E/office@boon.co.nz W/boon.co.nz

122 St Aubyn Street

MARCH 21 6.00PM AND 6.30PM SUNSET TIME: 7.34pm

NB: The following buildings have been fully surveyed and modelled by BTW limited. 122 St Aubyn Street 122A St Aubyn Street 122B St Aubyn Street Richmond Estate Buildings All other buildings are based on approximate data

from NPDC GIS Viewer, and a broad level city survey of building heights by BTW.

Additional shading to Northern elevation in March. Approx. 4 hours of the day affected by additional shading.

122A St Aubyn Street

122B St Aubyn Street Additional shading to Western

March

elevation, Northern elevation (from

balustrade) and building roof top in

Approx. 1.5 hours of the day affected by additional shading.

Additional shading limited to Western elevation and building roof top in March.

Approx. 3 hours of the day affected by additional shading.

Richmond Apartments

Additional shading to Northern elevation in March. Approx. 1.75 hours of the day affected by additional shading.

122B St Aubyn Street

Additional shading to Western elevation, Northern elevation (from balustrade) and building roof top in March Approx. 1.5 hours of the day

affected by additional shading.


Example of balustrade extension

122 St Aubyn Street

Additional shading to Northern elevation in March. Approx. 4 hours of the day affected by additional shading.

122A St Aubyn Street Additional shading limited to Western elevation and building roof

Approx. 3 hours of the day affected by additional shading.

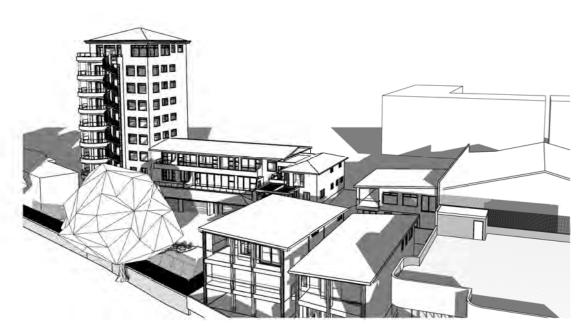

Sunset Shading - June Existing 4.00pm

Scale (A3)



Sunset Shading - June Proposed 4.00pm



Sunset Shading - June Existing 4.30pm



Sunset Shading - June Proposed 4.30pm

Proposed Sunset Shading Key Shadow of a Permitted Development Overlap - Shadow of a Permitted Development AND Shadow of the Proposed Development

Additional shading created by shadow of the Proposed

Date	Description
29.03.2021	RC RFI
01.07.2021	RC RFI
	29.03.2021

1-3 Dawson Street **RESOURCE CONSENT**

JULY | 2021


teamarchitects

JUNE 21 4.00PM AND 4.30PM SUNSET TIME: 5.08pm

NB: The following buildings have been fully surveyed and modelled by BTW limited. 122 St Aubyn Street 122A St Aubyn Street 122B St Aubyn Street Richmond Estate Buildings

14/07/21 02:43 PM 6592 1:100 SK5.02 2 Sunset Shadow Studies - June

A/131 Courtenay St, New Plymouth 4310, New Zealand P/06 757 3200 E/office@boon.co.nz W/boon.co.nz

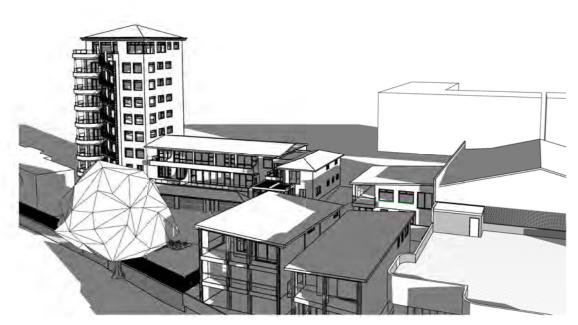

Sunset Shading - September Existing 5.30pm Scale (A3)



Sunset Shading - September Proposed 5.30pm



SUNSET TIME: 6.19pm

NB: The following buildings have been fully surveyed and modelled by BTW limited.

- 122 St Aubyn Street
- 122A St Aubyn Street
- 122B St Aubyn Street

Richmond Estate Buildings

All other buildings are based on approximate data from NPDC GIS Viewer, and a broad level city survey of building heights by BTW.

Richmond Apartments

Additional shading to Northern and Western elevation in September. Approx. 1.5 hours of the day affected by additional shading.

122 St Aubyn Street


Additional shading to Northern elevation in September. Approx. 3.25 hours of the day affected by additional shading.

122B St Aubyn Street

Additional shading to Western elevation and roof top in September. Approx. 1.25 hours of the day affected by additional shading.

122A St Aubyn Street

Additional shading limited to Western elevation and building roof ton in Sentember Approx. 2 hours of the day affected by additional shading on walls between 2.30-4.30pm.

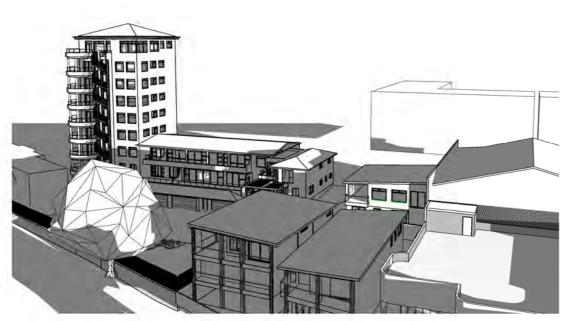


Sunset Shading - September Existing 6.00pm



Sunset Shading - September Proposed 6.00pm

Proposed Sunset Shading Key

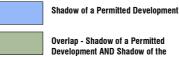

Proposed Development

Additional shading created by shadow of the Proposed

Date Description 29.03.2021 RC RFI 01.07.2021


1-3 Dawson Street

RESOURCE CONSENT JULY | 2021

14/07/21 02:43 PM

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6592 1:100 SK5.03 2 Sunset Shadow Studies - September A/131 Courtenay St, New Plymouth 4310, New Zealand P/06 757 3200 E/office@boon.co.nz W/boon.co.nz

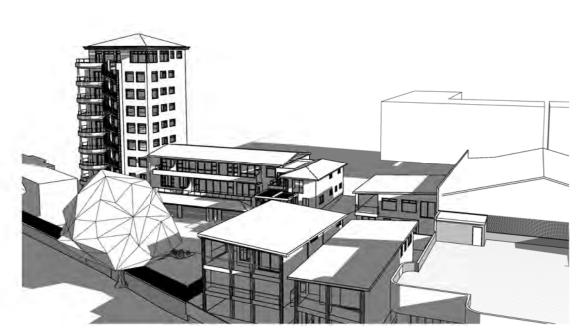


Sunset Shading - December Existing 7.00pm

Scale (A3)



Sunset Shading - December Proposed 7pm

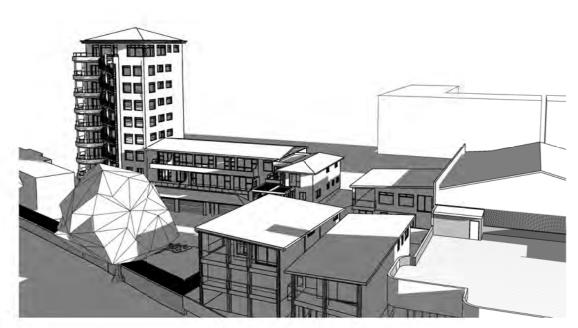

Sunset Shading - December Existing 7.30pm

Scale (A3)



Sunset Shading - December Proposed 7.30pm

Proposed Sunset Shading Key



Additional shading created by shadow of the Proposed Development

Rev	Date	Description
1	29.03.2021	RC RFI
2	01.07.2021	RC RFI
3	28.07.2021	RC RFI

RC RFI
RC RFI
RC RFI
RESOURCE CONSENT
JULY | 2021

| job no. | a3 scale | drawing no | SK5.04 | 3 Sunset Shadow Studies - December | 28/07/21 01:30 PM

1-3 Dawson Street
New Plymouth
RESOURCE CONSENT
JULY | 2021
teamarchitects

DECEMBER 21 7.00PM AND 7.30PM SUNSET TIME: 8.49pm

NB: The following buildings have been fully surveyed and modelled by BTW limited.

122 St Aubyn Street

122A St Aubyn Street


122B St Aubyn Street

Richmond Estate Buildings

A/131 Courtenay St, New Plymouth 4310, New Zealand P/06 757 3200 E/office@boon.co.nz W/boon.co.nz

Analysis of Additional Shading by Proposed and Permitted Developments - 122 St Aubyn Street

Proposed Development Shading

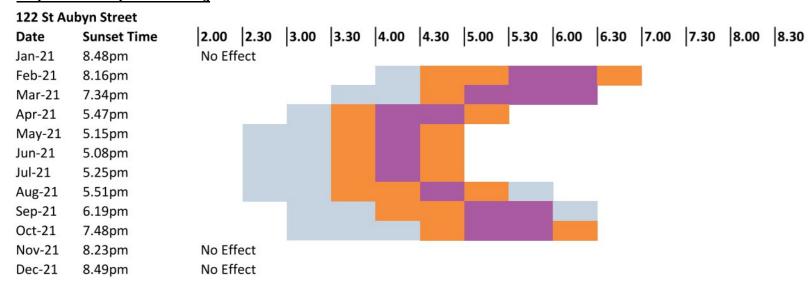


Permitted Development Shading

122 St Aubyn Street

Date	Sunset Time	2.00 2.30	3.00	3.30	4.00	4.30	5.00	5.30	6.00	6.30	7.00	7.30	8.00	8.30
Jan-21	8.48pm	No Effect			·					•				
Feb-21	8.16pm													
Mar-21	7.34pm			4										
Apr-21	5.47pm													
May-21	5.15pm													
Jun-21	5.08pm													
Jul-21	5.25pm													
Aug-21	5.51pm													
Sep-21	6.19pm													
Oct-21	7.48pm													
Nov-21	8.23pm													
Dec-21	8.49pm	No Effect												

Key

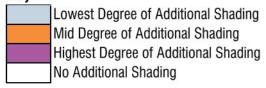

Proposed Design - Description of Shading Effects

122 St Aubyn Street is located to the South-East of the existing building at 1 Dawson Street, and is already subject to shading effects from the existing building.

The proposed development will have additional shading affects to the Northern walls of the building from February until October.

122 St Aubyn Street will experience the highest degee of additional shading when compared to the other analysed properties (122A, 122B and the Richmond Apartments).

There will be no additional shading affect to 122 from the proposed development during the summer months when the sun angle is high (November through to January).

Permitted Baseline - Description of Shading Effects

The creation of a permitted baseline development would also have additional shading effects on 122 St Aubyn Street.

In many months of the year (February, March, August, September, October and November) the shading effects of a permitted development would be greater than that of the proposed. There would be low degrees of additional shading in November, when the proposed development would have no effect.

In June and July between 4pm and 4.30pm, the shading effects of a permitted development would be less than that of the proposed development.

 Rev
 Date
 Description

 1
 29.03.2021
 RC RFI

 2
 01.07.2021
 RC RFI


 3
 28.07.2021
 RC RFI



| job no. | a3 scale | drawing no | SK5.05 | S Shading Effect Summary - 122 | print date | 28/07/21 12:44 PM

Analysis of Additional Shading by Proposed and Permitted Developments - 122A St Aubyn Street


Proposed Development Shading

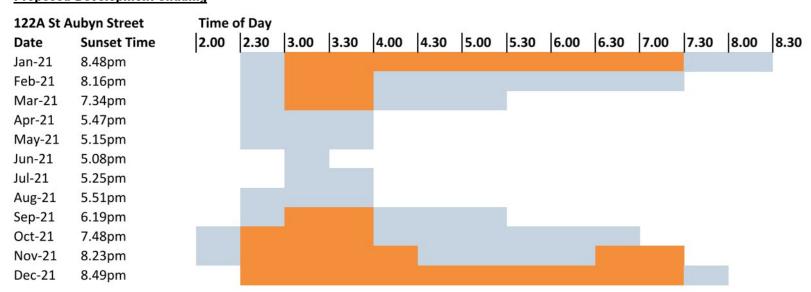

Permitted Development Shading

122A St Aubyn Street		Time	of Day												
Date	Sunset Time	2.00	2.30	3.00	3.30	4.00	4.30	5.00	5.30	6.00	6.30	7.00	7.30	8.00	8.3
Jan-21	8.48pm														
Feb-21	8.16pm														
Mar-21	7.34pm														
Apr-21	5.47pm														
May-21	5.15pm														
Jun-21	5.08pm														
Jul-21	5.25pm														
Aug-21	5.51pm														
Sep-21	6.19pm														
Oct-21	7.48pm														
Nov-21	8.23pm														
Dec-21	8.49pm														

Key

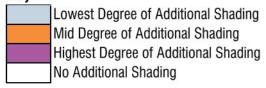

Proposed Design - Description of Shading Effects

122A St Aubyn Street is the closest property to the proposed development. It is located approximately 4 meters away from the North-Eastern wall of the existing building at 1 Dawson Street, and is already subject to shading effects in the afternoon throughout the year.

The proposed development will affect the Western wall and Roof Top of 122A St Aubyn Street during each month of the year. The additional shading affects will typically be a widening of the existing shading.

122A St Aubyn Street will experience the longest duration of additional shading when compared to the other analysed properties (122, 122B and the Richmond Apartments).

The highest degree of effect will be during the summer months, when the high sun angle will be affected by the additional height of the proposed development

The lowest degree of effect will be during the winter months, when the low sun angles are already affected by the existing building

Permitted Baseline - Description of Shading Effects

The creation of a permitted baseline development would also have additional shading effects on 122A St Aubyn Street.

In many months of the year (January, February, March, June, July, September, October, November, December) the shading effects of a permitted development would be less shading, or in effect for a shorter amount of time than that of the proposed.

In June and July, the shading effects of a permitted development would be in effect for longer than that of the proposed.

In other months the shading effects would be the same.


Rev	Date	Descriptio
1	29.03.2021	RC RFI
2	01.07.2021	RC RFI
3	28.07.2021	RC RFI



| job no. | a3 scale | drawing no | rev | drawing title | SK5.06 | S | Shading Effect Summaries - 122A | print date | 28/07/21 12:44 PM

Analysis of Additional Shading by Proposed and Permitted Developments - 122B St Aubyn Street


Proposed Development Shading

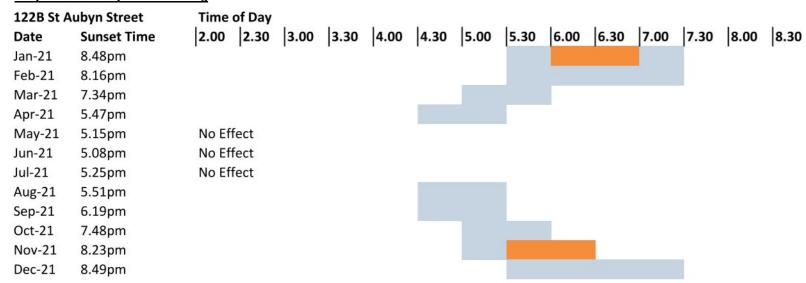

Permitted Development Shading

122B St Aubyn Street		Time	of Day												
Date	Sunset Time	2.00	2.30	3.00	3.30	4.00	4.30	5.00	5.30	6.00	6.30	7.00	7.30	8.00	8.30
Jan-21	8.48pm					-									
Feb-21	8.16pm														
Mar-21	7.34pm	No Eff	fect												
Apr-21	5.47pm	No Eff	fect												
May-21	5.15pm	No Eff	fect												
Jun-21	5.08pm	No Eff	fect												
Jul-21	5.25pm	No Eff	fect												
Aug-21	5.51pm	No Eff	fect												
Sep-21	6.19pm	No Eff	fect												
Oct-21	7.48pm														
Nov-21	8.23pm														
Dec-21	8.49pm														

Key

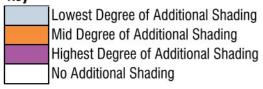

Proposed Design - Description of Shading Effects

122B St Aubyn Street is approximately 15m to the East of the existing building at 1 Dawson Street, and is already subject to shading effects in the afternoon throughout the year.

The proposed development will have additional shading affects to the upper part of the Western wall and Roof Top in spring, summer and autumn months. It will have a slight affect to the Northern wall in the summer months also.

There will be no additional shading affect to 122B from the proposed development during the winter months.

Permitted Baseline - Description of Shading Effects

The creation of a permitted baseline development would also have additional shading effects on 122B St Aubyn Street.

In many months of the year (January, March, April, August, September, November) the shading effects of a permitted development would be less than that of the proposed. In other months the shading effects would be the same.

Rev Date Description
1 28.07.2021 RC RFI



| job no. | a3 scale | drawing no | SK5.07 | The scale | Sk5.07 | Shading Effect Summaries - 122B | print date | 28/07/21 12:44 PM

<u>Analysis of Additional Shading by Proposed and Permitted Developments - Richmond Estate Apartments</u>

Proposed Development Shading

Richmond Estate (Collective)


KICIIIIOIIU	Estate (Collective)														
Date	Sunset Time	2.00	2.30	3.00	3.30	4.00	4.30	5.00	5.30	6.00	6.30	7.00	7.30	8.00	8.30
Jan-21	8.48pm	No Eff	ect												
Feb-21	8.16pm	No Eff	ect												
Mar-21	7.34pm														
Apr-21	5.47pm														
May-21	5.15pm														
Jun-21	5.08pm														
Jul-21	5.25pm														
Aug-21	5.51pm														
Sep-21	6.19pm														
Oct-21	7.48pm														
Nov-21	8.23pm	No Eff	ect												
Dec-21	8.49pm	No Eff	ect												

Permitted Development Shading

Richmond Estate (Collective)

Michillona	Litate (Conective)															
Date	Sunset Time	2.00	2.30	3.00	3.30	4.00	4.30	5.00	5.30	6.00	6.30	7.00	7.30	8.00	8.30	
Jan-21	8.48pm	No Eff	fect													
Feb-21	8.16pm	No Eff	fect													
Mar-21	7.34pm															
Apr-21	5.47pm															
May-21	5.15pm															
Jun-21	5.08pm	No Eff	fect													
Jul-21	5.25pm															
Aug-21	5.51pm															
Sep-21	6.19pm															
Oct-21	7.48pm															
Nov-21	8.23pm	No Eff	fect													
Dec-21	8.49pm	No Eff	fect													

Key

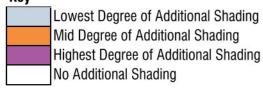

Proposed Design - Description of Shading Effects

The Richmond Estate apartments are approximately 50m to the South-East of the existing building at 1 Dawson Street, and are already subject to shading effects in the afternoon in the winter months of the year.

The proposed development will have additional shading affects to the Northern and Western walls of these buildings during March-October. The largest impact will be effected in the autumn and spring equinox months - March and September.

There will be no additional shading affect to the Richmond Estate from the proposed development during the late autum and summer months (November-February).

Permitted Baseline - Description of Shading Effects

The creation of a permitted baseline development would also have additional shading effects on the Richmond Estate Apartments.

In many months of the year (April, May, June. August) the shading effects of a permitted development would be less than that of the proposed. In other months the shading effects would be the same.


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 Date
 Description

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 28.07.2021
 RC RFI



| job no. | 6592 | SK5.08 | drawing no | rev | drawing title | Sk5.08 | Shading Effect Summaries - Richmond | 28/07/21 12:44 PM

Analysis of Additional Shading created by Proposed Development, compared against Existing Shading

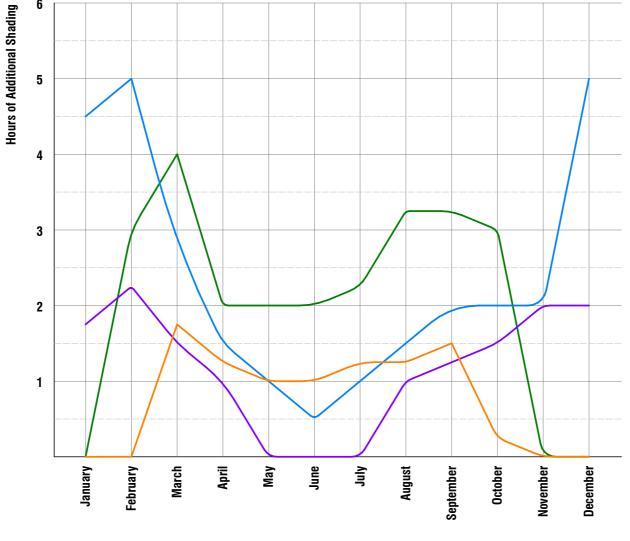

Properties Analysed

122 St Aubyn Street

122A St Aubyn Street

122B St Aubyn Street

Richmond Apartments

12 MONTH SHADING STUDY

RevDateDescription101.07.2021RC RFI

1-3 Dawson Street
New Plymouth
RESOURCE CONSENT
JULY 2021

Teamarchitects

job no. 6592 a3 scale drawing no rev drawing title SK5.10 Sunset Shadow Studies - Graph print date 14/07/21 04:17 PM