

Our Reference: 190983

29th March 2021

Luke Balchin New Plymouth District Council Private Bag 2025 New Plymouth 4340

Delivered electronically to: Luke.Balchin@npdc.govt.nz

Dear Luke,

### Response to RMA Section 92 Request for Further Information - LUC21/47890

The purpose of this letter is to provide the information requested under Section 92 of the RMA in the NPDC letter dated 12 March 2021. The numbering of the information provided below corresponds with that of the requests. Amended and additional drawings and supporting information is provided within the drawings attached as **Appendix A** to this response. We understand that you are currently on annual leave but that you have made arrangements for the notification process to progress in your absence.

- 1. Please find attached (Appendix A) a set of elevation drawings that omit comparisons to the previous design. A new version of each elevation drawing has been added to the drawing set. These are numbered SK3.01.1, SK3.02.1, SK3.03.1 and SK3.04.1.
- 2. Due to the slope of the terrain over the site, as well as the changing height of the proposed building, there are some variations in the infringing height of the building. The best elevation to view the height infringement of the proposal is the Southern Elevation. That being said, the 1.4 m infringement on SK3.03 is overly conservative it is actually more like 0.7 m on this elevation as the 1.4 m was measuring to the top of the building on the Dawson Street side.
- 3. The purpose of the additional height queried is a design feature of the space at the top of the stairs to create volume in the space for arrival into the home, and a space for the applicant to hang art. This will be a 4 m ceiling height at the top of the stairs and lounge area, which reduces to a 3 m ceiling height in the kitchen and dining. The floor level then steps back down where the new building overlaps the existing building, and this creates a 3.7 m ceiling height in the main living and main bedrooms.
- 4. We agree with Council that there is a permitted baseline argument available. However, we disagree that illustrating a building of 10m in height with 100% coverage of the site is misleading. We consider it is a helpful and necessary exercise to undertake to provide an understanding of what the Operative District Plan permits as of right on the site and the effects of such a permitted development. This allows the effects from a development that is permitted by the District Plan to be compared against the effects from the proposed development after which the permitted effects can be discounted. The approach taken is entirely aligned with common permitted baseline practice. We draw your attention to the Quality Planning Website commentary on the permitted baseline which states:

'The purpose of the permitted baseline test is to isolate and make effects of activities on the environment that are permitted by the plan or NES, irrelevant. When applying the permitted baseline such effects cannot then be taken into account when assessing

the effects of a particular resource consent application. The baseline has been defined by case law as comprising non-fanciful (credible) activities that would be permitted as of right by the plan in question.'

While it is not the applicant's intention to undertake the permitted development provided in the application, we consider it is a credible development for the site and would be an alternative to putting significant investment into the existing building both in the form of earthquake strengthening, office upgrades and adding an apartment development.

The suggestion that a more useful comparison would be showing shading from the proposed buildings GFA with a permissive height ignores the fact that the existing building is already over the permitted height threshold. This comparison also would not allow for an assessment of the permitted baseline defined by the relevant rules in the Operative District Plan. If an alternative development was shown that did not propose any increase in height the additional floor area required for the apartment would need to be created by increasing the footprint of the building resulting in the potential for additional and potentially greater adverse effects.

The shading drawings have been amended to more clearly show the additional shading created by the additional height of the building.

- 5. The shading drawings have also been amended and expanded on to provide further information on the locations of additional shading and times of the day and year when this additional shading occurs. As there is minimal additional shading to the west of the application site this assessment focusses on properties located to the east of the application site. The drawings have been supplemented with a written summary and a graph to help better understand the additional shading. In addition, any of the affected parties are welcome to view the 3D shading models at the Boon Architect's offices by appointment.
- 6. As per response to question 5.
- 7. The space between the proposed dwelling and southern boundary has been kept clear to minimise the impact on neighbouring properties to south (including 122 St Aubyn Street), and to maintain amenity for potential future development on the 132 St Aubyn Street site (also in the ownership of the applicant). There are also added practical benefits including reduced fire rating requirements by not building on the boundary, and the creation of a fire egress path for occupants to Dawson Street from the rear of the dwelling.
- 8. The space referred to is most likely to be an area that contains raised vegetable gardens and lawn, and possibly a clothesline. There is little scope to use this area as mitigation for the additional height of the building. The other items are matters of landscape design that are yet to be determined. However, these elements will have no effect on the over-height portion of the building i.e. above 10 m.
- 9. This green strip shown on road reserve is an error and has been removed from drawing SK2.02. Drawings SK0.01, SK2.01 and SK2.02 have been updated to remove the grass strip on the road reserve. Refer to Appendix A for amended plans.
- 10. The assessment criteria for Bus13 do not refer to landscape elements described in this Section 92 request item. The additional height of the proposed building will not adversely affect the character and visual amenity of the surrounding area for the reasons described in the LVIA. The LVIA does not refer to landscape design as a method by which to mitigate effects of the extra height, rather it lists mitigation measures as follows (Chapter 7 of the LVIA);

In this regard, specific mitigation measures are:

- the addition is 'stepped back' on the seaward side thereby avoiding any dominance effects on the coastal walkway;
- there is a high degree of glazing that provides modulation to the façades and provides a degree of transparency;
- the roof is flat in order to be no taller than necessary;
- the existing building will be painted a grey colour, more recessive than the building is presently coloured;
- the southern extension comprises a material with a neutral palette;
- the colour of the new addition will be recessive, with cladding materially yet to be finalised.

It would be appreciated if it can be confirmed whether the Section 92 request queries are considered to be fulfilled and the notification decision progressed.

Yours sincerely,

Cam Twigley MNZPI

**Director, Planning and Environment** 

### **APPENDICES**

Appendix A Supplementary and Amended Drawings

# **APPENDIX A SUPPLEMENTARY AND AMENDED DRAWINGS**

# 1-3 Dawson Street

**New Plymouth** 

ISSUED FOR:
RESOURCE CONSENT

6592



# **Disclaimer**

Accuracy of the shading diagrams shown is affected by the coordinated data available to this project.

### Modelling:

- The original building at 1 Dawson Street and immediately surrounding topography has been surveyed by BTW Ltd. to provide accurate building outlines, relative levels and heights.
- The contours of the extended neighbourhood geography, and location of neighbouring properties are created using data from NPDC GIS database for land contours and property lines.
- All existing neighbouring buildings are shown approximate only, based on data from NPDC GIS Maps, and photographs and observations of their relative locations.


### Shadows:

- The generation of shading is created via. the in-built location data in the Autodesk Revit software used by BOON
- We have coorelated the shading data with actual photographs taken on site at a specific time and day, as demonstrated on drawing SK4.00.

e Description 1-



| job no. | a3 scale | drawing no rev drawing title | print date | 29/03/21 02:26 PM

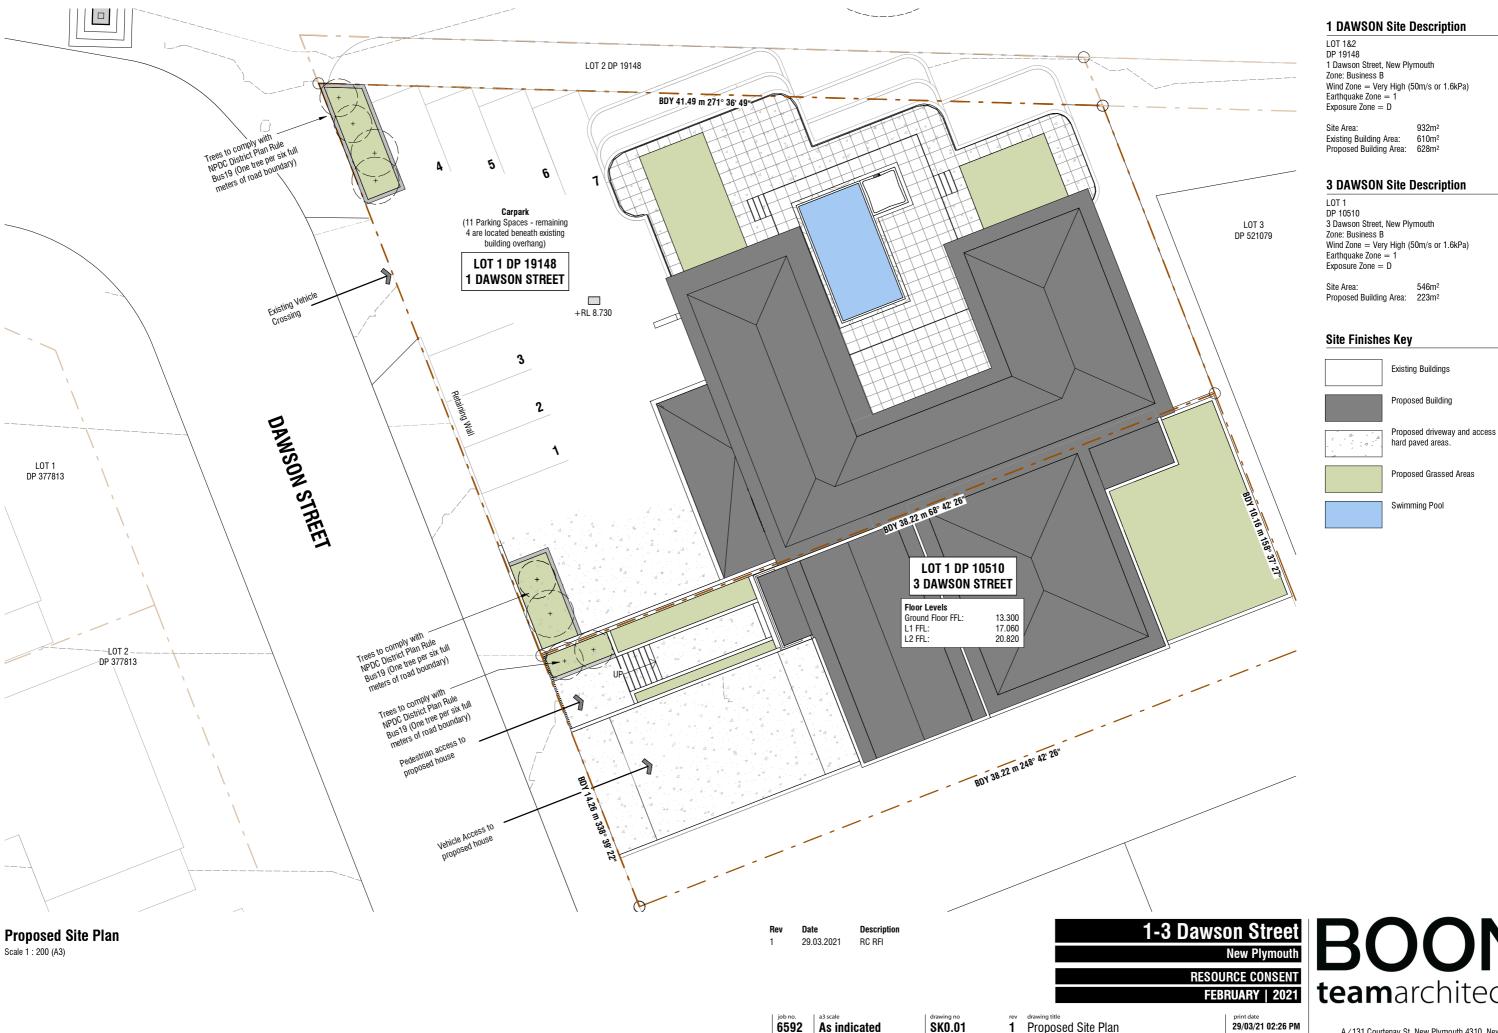

Wind Zone = Very High (50m/s or 1.6kPa)

Existing Buildings

hard paved areas.

Proposed Grassed Areas

Swimming Pool

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29.03.2021 RC RFI 1-3 Dawson Street


FEBRUARY | 2021

job no. a3 scale 1:200 print date 29/03/21 02:26 PM rev drawing title

1 Parking Plan SK2.01

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3 Dawson Ground Floor

Scale 1: 200 (A3)

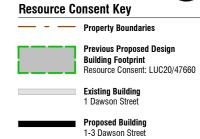DAWSON STREET

ev Date Description 29.03.2021 RC RFI 1-3 Dawson Street
New Plymouth
RESOURCE CONSENT
FEBRUARY | 2021

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job no. a3 scale 6592 1:200

SK2.02

1 3 Dawson Proposed Ground Floor

print date 29/03/21 02:26 PM



Previous Proposed Design Building Footprint Resource Consent: LUC20/47660

Existing Building
1 Dawson Street

Proposed Building 1-3 Dawson Street

Resource Consent Key
Property Boundaries



# 3 Dawson Proposed Level 1 Plan

Scale 1: 200 (A3)

Date Description 1-3 Dawson Street

New Plymouth

RESOURCE CONSENT
FEBRUARY | 2021

WSON Street
New Plymouth
ESOURCE CONSENT
FEBRUARY | 2021

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 $\begin{bmatrix} \text{job no.} \\ \textbf{6592} & \textbf{1:200} \end{bmatrix} \text{ a3 scale } \\ \textbf{1:200} & \textbf{SK2.03} \end{bmatrix} \text{ adapting no scale } \\ \textbf{SK2.03} & \textbf{3 Dawson Proposed Level 1} \end{bmatrix} \text{ print date } \\ \textbf{29/03/21 02:26 PM}$ 






- Property Boundaries



Previous Proposed Design Building Footprint
Resource Consent: LUC20/47660

Existing Building
1 Dawson Street

Proposed Building 1-3 Dawson Street

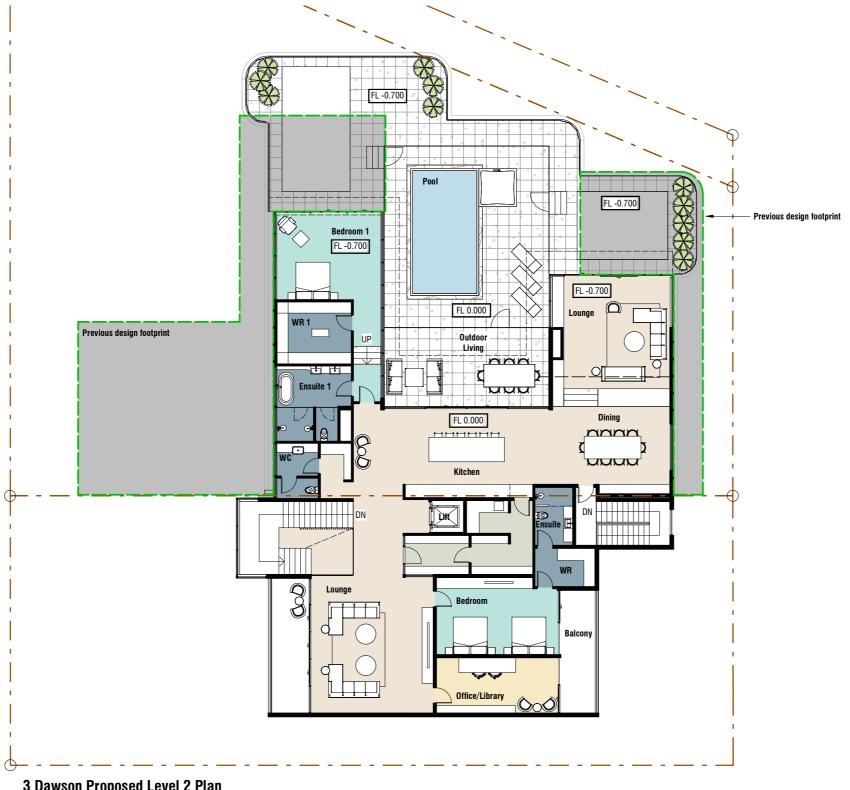

### 3 Dawson Proposed Level 2 Plan


Scale 1 : 200 (A3)

1-3 Dawson Street

FEBRUARY | 2021

job no. a3 scale 1:200 print date 29/03/21 02:26 PM SK2.04 3 Dawson Proposed Level 2


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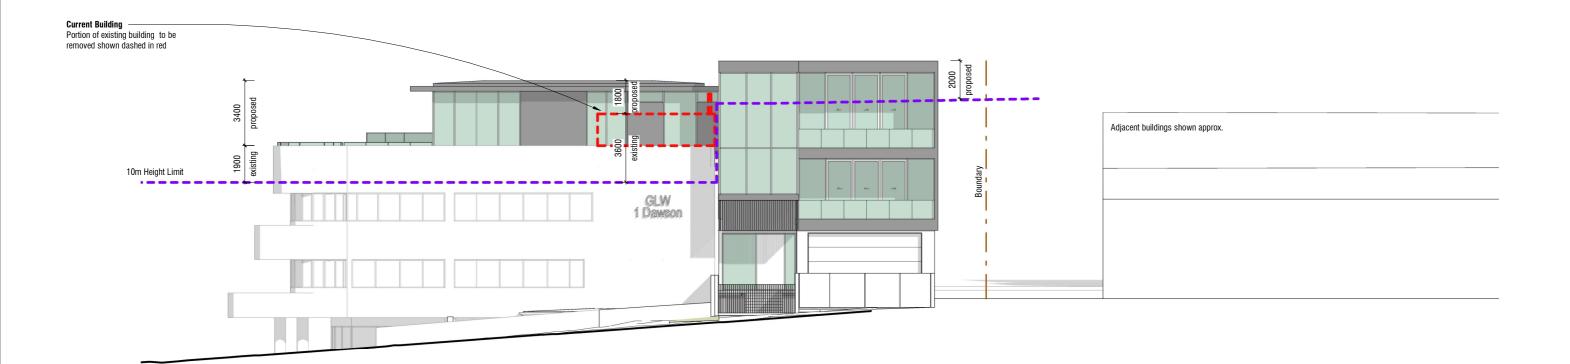


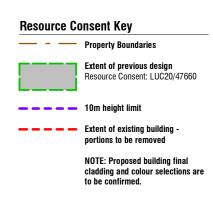


# **Proposed West Elevation**


Scale 1 : 200 (A3)




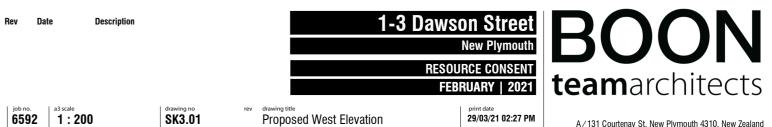

# **Proposed West Elevation - Proposed Only** Scale 1 : 200 (A3)

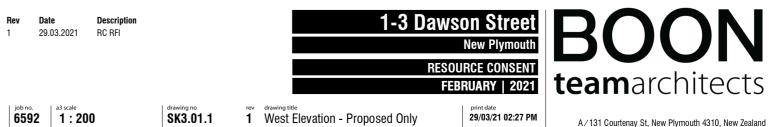


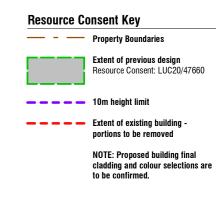

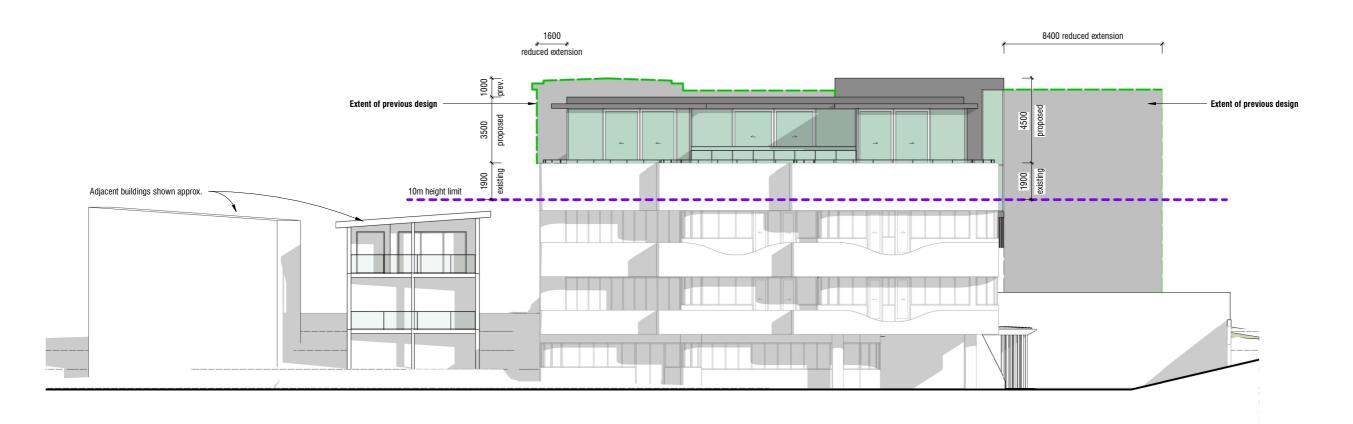

### **Proposed North Elevation**


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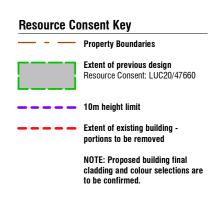


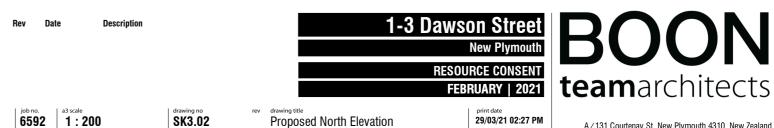


# **Proposed North Elevation - Proposed Only**

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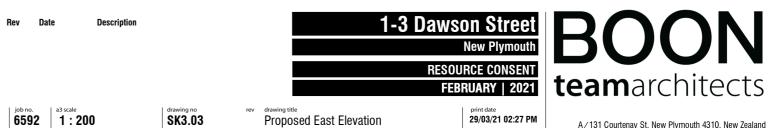





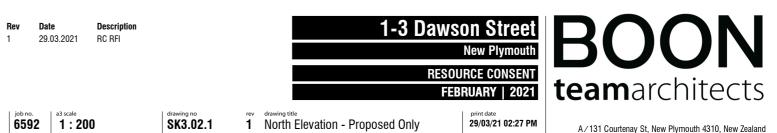
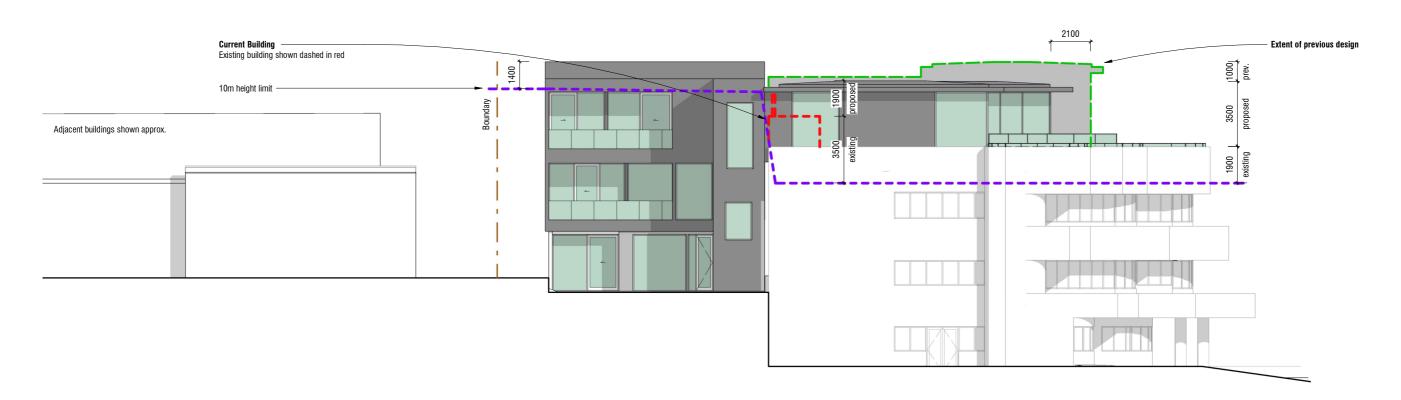
# **Proposed East Elevation**

Scale 1 : 200 (A3)




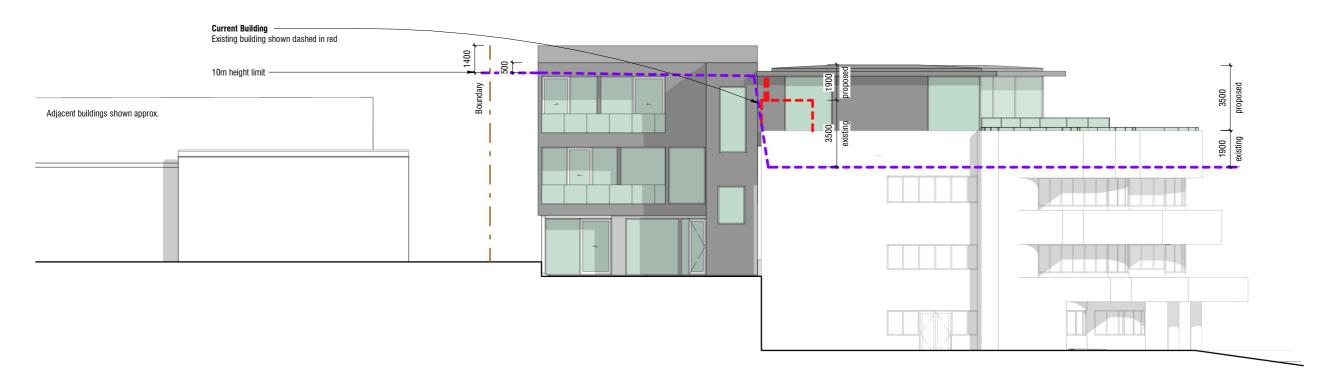

# **Proposed East Elevation - Proposed Only**


Scale 1 : 200 (A3)



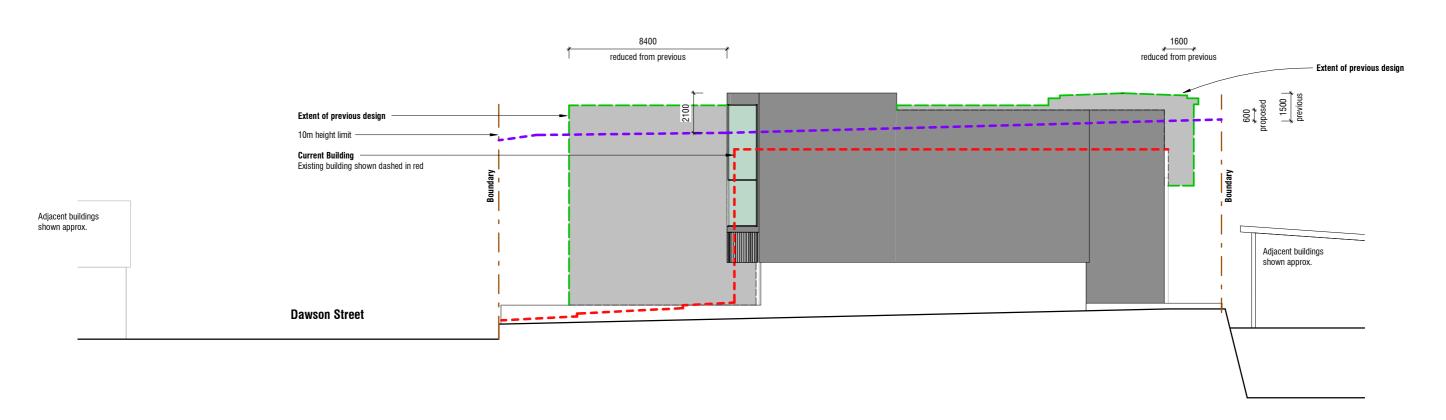


# **Proposed South Elevation**

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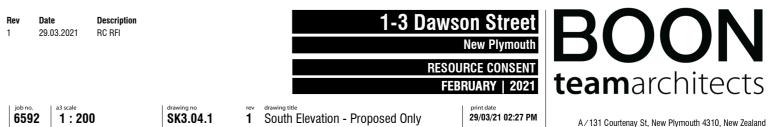


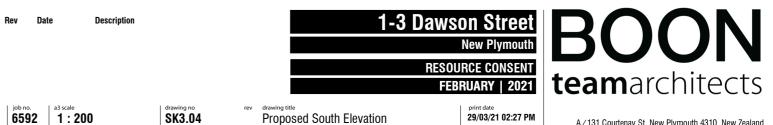ITRACTORS MUST VERIFY ALL DIMENSIONS ON THE JOB BEFORE COMMENCING ANY WORK. DO NOT SCALE. © COPYRIGHT ON THESE DRAWINGS IS RESERVED.

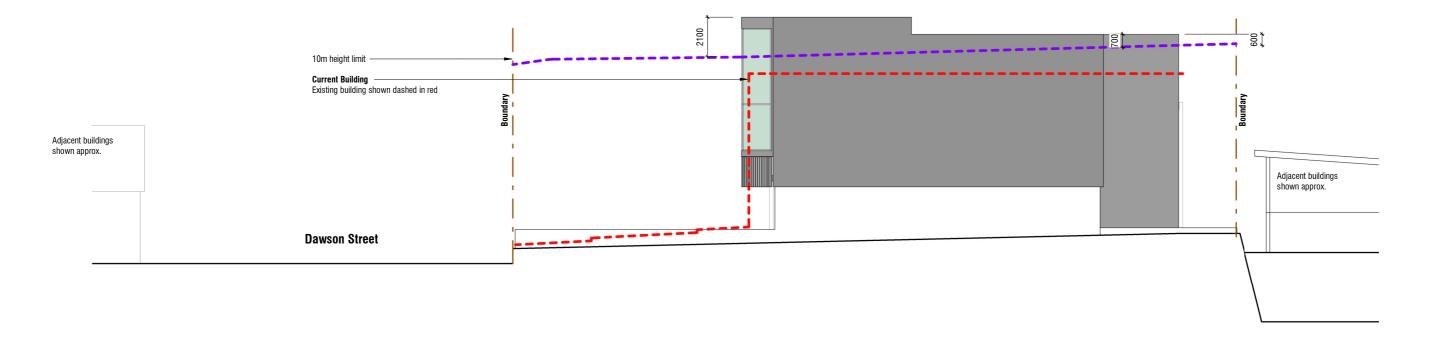


# **Proposed South Elevation - Proposed Only**

Scale 1 : 200 (A3)



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1-3 Dawson Street
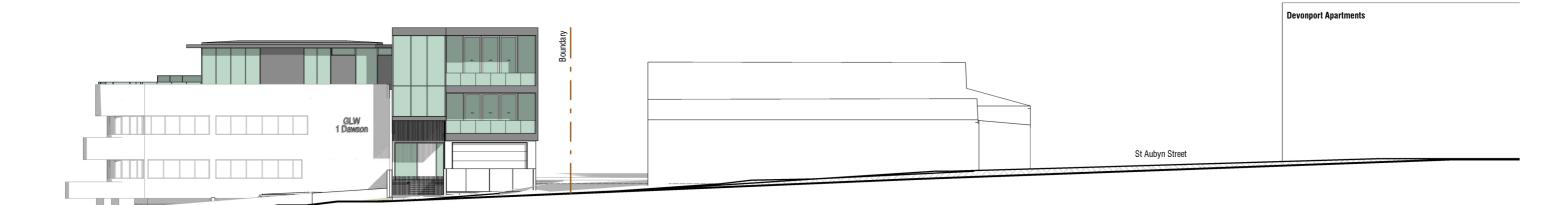
# **Dawson Street Elevation**


Scale1: 300 (A3)



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Photo Taken from roof of 1 Dawson Street July 09 2020 - 4.34pm



Exising Shadows - July 09 4.34pm

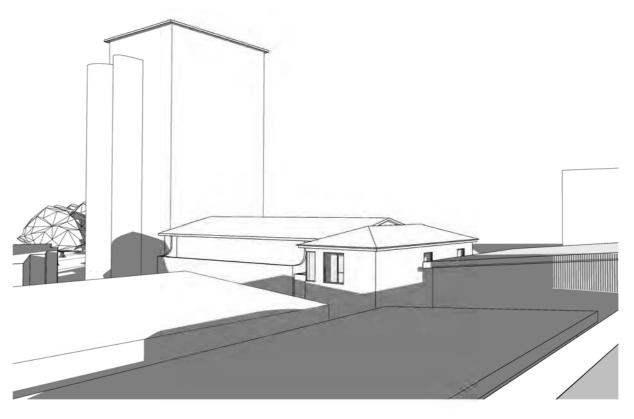Scale (A3)

NB: ALL EXISTING NEIGHBOURING BUILDINGS; SIZE/SHAPE/HEIGHT/LOCATION/LEVELS ETC. ARE SHOWN APPROXIMATE ONLY AND ARE NOT BASED ON SURVEYED INFORMATION

ALL SHADOWS SHOWN ARE APPROXIMATE ONLY

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job no. 6592

1-3 Dawson Street

FEBRUARY | 2021

Shadow Study Check View - July 09

print date 29/03/21 02:31 PM

A/131 Courtenay St, New Plymouth 4310, New Zealand P/06 757 3200 E/office@boon.co.nz W/boon.co.nz

SK4.00

# MARCH (Sunrise at 7.30am)

# **SUNRISE SHADOW STUDY -** 21 MARCH

- 8.00AM
- 9.00AM
- 10.00AM

# Shading Diagrams Key

**Site Boundaries** 

**Existing Buildings** 

**Proposed Building** 

**Existing Shadows** 

District Plan:

Shadow of a 'Permitted Building' Compliant under NPDC Operative

**Shadow of Proposed Development** Hatched area includes Existing and

10m high

Infringing Shadow - beyond shadow of existing/permitted

Affect of shadows not considered within the boundaries of the applicants boundary

Proposed buildings.

Extent of Ownership 1-3 Dawson St.

# **SHADOW STUDY - MARCH**

(Sunrise at 7.30am)

# 21 MARCH - 8.00AM



Shadow Study - March 8am

Scale 1:500 (A3)

NB: ALL EXISTING NEIGHBOURING BUILDINGS; SIZE/SHAPE/HEIGHT/LOCATION/LEVELS ETC. ARE SHOWN APPROXIMATE ONLY AND ARE NOT BASED ON SURVEYED INFORMATION

ALL SHADOWS SHOWN ARE APPROXIMATE ONLY

Rev Date Description
1 29.03.2021 RC RFI

1-3 Dawson Street
New Plymouth

RESOURCE CONSENT FEBRUARY | 2021

print date 29/03/21 02:31 PM **BOON** teamarchitects

6592 As indicated SK4.01 1 Shadow Study - March 8.00am

# **SHADOW STUDY - MARCH**

(Sunrise at 7.30am)


# 21 MARCH - 9.00AM



Shadow Study - March 9am

Scale 1:500 (A3)



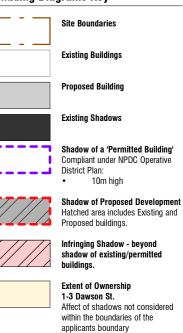

NB: ALL EXISTING NEIGHBOURING BUILDINGS; SIZE/SHAPE/HEIGHT/LOCATION/LEVELS ETC. ARE SHOWN APPROXIMATE ONLY AND ARE NOT BASED ON SURVEYED INFORMATION

ALL SHADOWS SHOWN ARE APPROXIMATE ONLY

Date Description 29.03.2021 RC RFI

1-3 Dawson Street

FEBRUARY | 2021

**team**architects print date 29/03/21 02:31 PM

6592 As indicated SK4.02 1 Shadow Study - March 9.00am

# **Shading Diagrams Key**

**Site Boundaries** 

**Existing Buildings** 

**Proposed Building** 

**Existing Shadows** 

District Plan: 10m high

Proposed buildings.

**Extent of Ownership** 1-3 Dawson St.

Shadow of a 'Permitted Building' Compliant under NPDC Operative

**Shadow of Proposed Development** Hatched area includes Existing and

Infringing Shadow - beyond shadow of existing/permitted

Affect of shadows not considered within the boundaries of the applicants boundary

# **SHADOW STUDY - MARCH**

(Sunrise at 7.30am)

# 21 MARCH - 10.00AM



Shadow Study - March 10am

Scale 1:500 (A3)

NB: ALL EXISTING NEIGHBOURING BUILDINGS; SIZE/SHAPE/HEIGHT/LOCATION/LEVELS ETC. ARE SHOWN APPROXIMATE ONLY AND ARE NOT BASED ON SURVEYED INFORMATION

ALL SHADOWS SHOWN ARE APPROXIMATE ONLY

Date Description 29.03.2021 RC RFI

1-3 Dawson Street

FEBRUARY | 2021

6592 As indicated SK4.03 1 Shadow Study - March 10.00am

print date 29/03/21 02:31 PM





# **SUNRISE SHADOW STUDY -** 21 JUNE

- 8.00AM
- 9.00AM
- 10.00AM

# Shading Diagrams Key

**Site Boundaries** 

**Existing Buildings** 

**Proposed Building** 

**Existing Shadows** 

District Plan:

• 10m high

Proposed buildings.

Extent of Ownership 1-3 Dawson St.

Shadow of a 'Permitted Building' Compliant under NPDC Operative

**Shadow of Proposed Development** Hatched area includes Existing and

Infringing Shadow - beyond shadow of existing/permitted

Affect of shadows not considered within the boundaries of the applicants boundary

# **SHADOW STUDY - JUNE**

(Sunrise at 7.45am)

# 21 JUNE - 8.00AM



Shadow Study - June 8am

Scale 1:500 (A3)

Note: Infringing shadow is removed From 1 Hine Street by 8.10am From 3A Hine Street by 8.20am From 4 Dawson Street by 8.10am From 4A Dawson Street by 8.20am

NB: ALL EXISTING NEIGHBOURING BUILDINGS; SIZE/SHAPE/HEIGHT/LOCATION/LEVELS ETC. ARE SHOWN APPROXIMATE ONLY AND ARE NOT BASED ON SURVEYED INFORMATION

ALL SHADOWS SHOWN ARE APPROXIMATE ONLY

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 Date
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 1
 29.03.2021
 RC RFI

1-3 Dawson Street

New Plymouth

RESOURCE CONSENT

**BOON** teamarchitects

6592 As indicated

SK4.04

1 Shadow Study - June 8.00am


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FEBRUARY | 2021

# **SHADOW STUDY - JUNE**

(Sunrise at 7.45am)

# 21 JUNE - 9.00AM

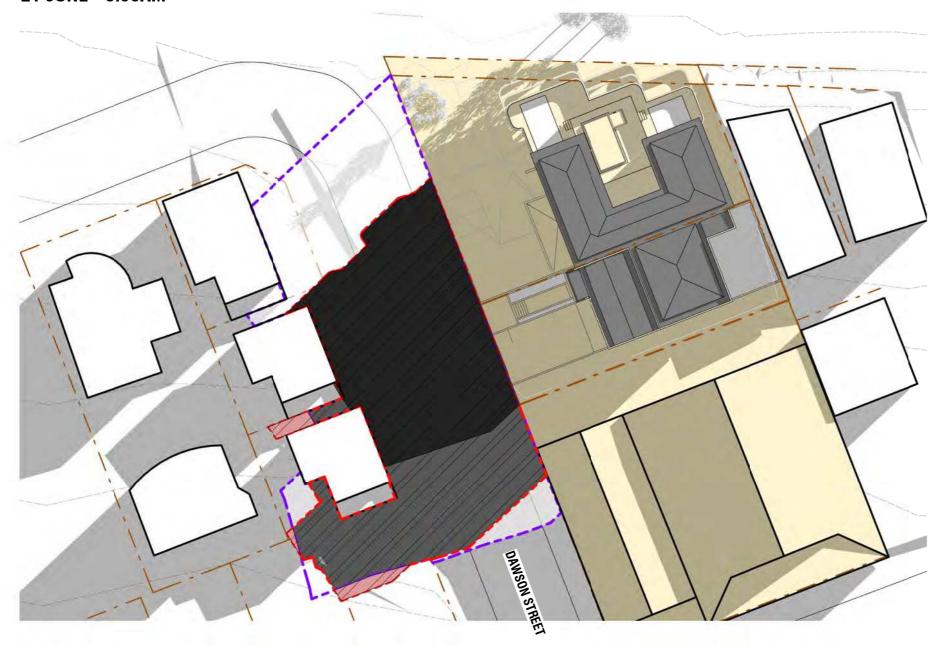

Shadow Study - June 9am

Scale 1:500 (A3)

Date Description 29.03.2021 RC RFI

1-3 Dawson Street

FEBRUARY | 2021

6592 As indicated SK4.05 1 Shadow Study - June 9.00am

print date 29/03/21 02:31 PM

**Shading Diagrams Key** 

**Site Boundaries Existing Buildings Proposed Building Existing Shadows** Shadow of a 'Permitted Building' Compliant under NPDC Operative District Plan: 10m high **Shadow of Proposed Development** Hatched area includes Existing and Proposed buildings. Infringing Shadow - beyond shadow of existing/permitted

Extent of Ownership 1-3 Dawson St.

Affect of shadows not considered within the boundaries of the applicants boundary


NB: ALL EXISTING NEIGHBOURING BUILDINGS; SIZE/SHAPE/HEIGHT/LOCATION/LEVELS ETC. ARE SHOWN APPROXIMATE ONLY AND ARE NOT BASED ON SURVEYED INFORMATION

ALL SHADOWS SHOWN ARE APPROXIMATE ONLY

(Sunrise at 7.45am)

**SHADOW STUDY - JUNE** 


21 JUNE - 10.00AM

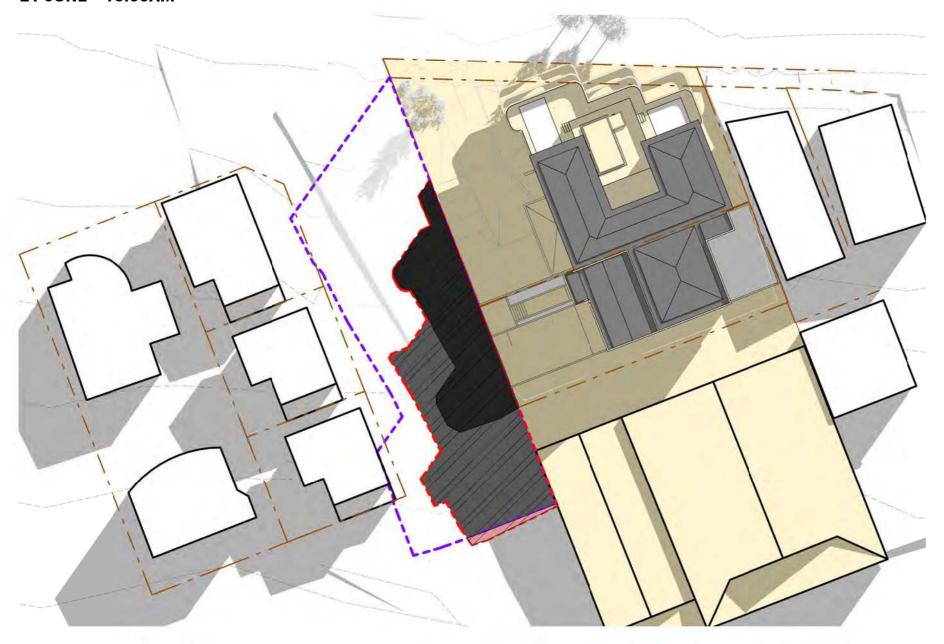

Shadow Study - June 10am

Scale 1:500 (A3)



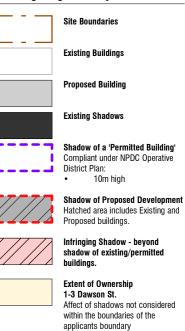

NB: ALL EXISTING NEIGHBOURING BUILDINGS; SIZE/SHAPE/HEIGHT/LOCATION/LEVELS ETC. ARE SHOWN APPROXIMATE ONLY AND ARE NOT BASED ON SURVEYED INFORMATION

ALL SHADOWS SHOWN ARE APPROXIMATE ONLY

RevDateDescription129.03.2021RC RFI

1-3 Dawson Street

New Plymouth

RESOURCE CONSENT

FEBRUARY | 2021

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6592 As indicated

SK4.06 1

1 Shadow Study - June 10.00am

print date 29/03/21 02:31 PM

# SEPTEMBER

(Sunrise at 6.15am)


# **SUNRISE SHADOW STUDY -** 21 SEPTEMBER

- 7.00AM
- 8.00AM
- 9.00AM

# **SHADOW STUDY - SEPTEMBER**

(Sunrise at 6.15am)

**21 SEPTEMBER - 7.00AM** 

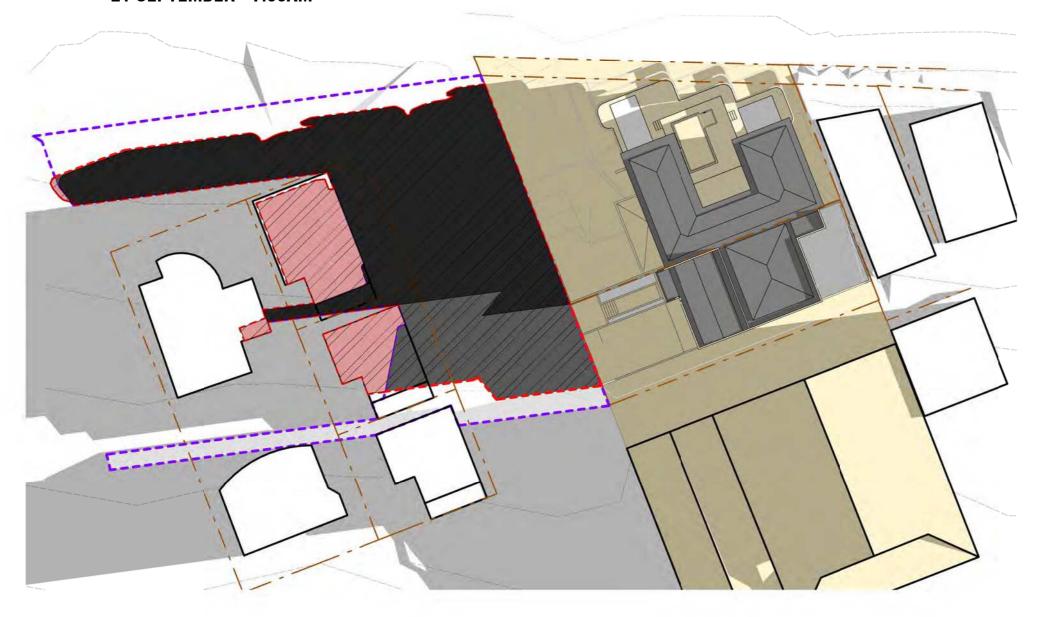

Shadow Study - Sept 7am

Scale 1:500 (A3)



**Site Boundaries Existing Buildings** 



**Proposed Building** 



**Existing Shadows** 



Shadow of a 'Permitted Building' Compliant under NPDC Operative





**Shadow of Proposed Development** Hatched area includes Existing and



Infringing Shadow - beyond shadow of existing/permitted



Extent of Ownership 1-3 Dawson St.

Affect of shadows not considered within the boundaries of the applicants boundary

NB: ALL EXISTING NEIGHBOURING BUILDINGS; SIZE/SHAPE/HEIGHT/LOCATION/LEVELS ETC. ARE SHOWN APPROXIMATE ONLY AND ARE NOT BASED ON SURVEYED INFORMATION

ALL SHADOWS SHOWN ARE APPROXIMATE ONLY

Date 29.03.2021

Description RC RFI

1-3 Dawson Street

FEBRUARY | 2021

print date 29/03/21 02:32 PM

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6592 As indicated SK4.07 1 Shadow Study - September 7.00am

# **SHADOW STUDY - SEPTEMBER**

(Sunrise at 6.15am)


# 21 SEPTEMBER - 8.00AM



Shadow Study - Sept 8am

Scale 1:500 (A3)

### **Shading Diagrams Key**

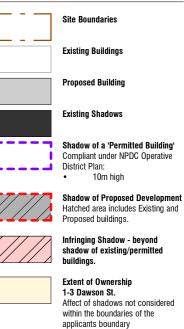

NB: ALL EXISTING NEIGHBOURING BUILDINGS; SIZE/SHAPE/HEIGHT/LOCATION/LEVELS ETC. ARE SHOWN APPROXIMATE ONLY AND ARE NOT BASED ON SURVEYED INFORMATION

ALL SHADOWS SHOWN ARE APPROXIMATE ONLY

RevDateDescription129.03.2021RC RFI

1-3 Dawson Street

New Plymouth

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**BOON** teamarchitects

| drawing no | SK4.08 | Shadow Study - September 8.00am

# **SHADOW STUDY - SEPTEMBER**

(Sunrise at 6.15am)


# 21 SEPTEMBER - 9.00AM



Shadow Study - Sept 9am

Scale 1:500 (A3)

### **Shading Diagrams Key**

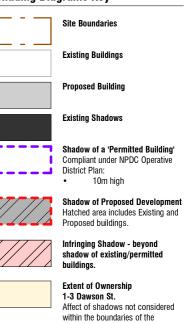

applicants boundary

NB: ALL EXISTING NEIGHBOURING BUILDINGS; SIZE/SHAPE/HEIGHT/LOCATION/LEVELS ETC. ARE SHOWN APPROXIMATE ONLY AND ARE NOT BASED ON SURVEYED INFORMATION

ALL SHADOWS SHOWN ARE APPROXIMATE ONLY

Date Description 29.03.2021 RC RFI

1-3 Dawson Street

FEBRUARY | 2021

6592 As indicated SK4.09 1 Shadow Study - September 9.00am

print date 29/03/21 02:32 PM

# DECEMBER

(Sunrise at 5.55am)

# **SUNRISE SHADOW STUDY -** 21 DECEMBER

- 7.00AM
- 8.00AM
- 9.00AM

# **Shading Diagrams Key**





**Existing Buildings Proposed Building** 



**Existing Shadows** 



Shadow of a 'Permitted Building' Compliant under NPDC Operative 10m high



**Shadow of Proposed Development** Hatched area includes Existing and Proposed buildings.



Infringing Shadow - beyond shadow of existing/permitted




**Extent of Ownership** 1-3 Dawson St. Affect of shadows not considered

within the boundaries of the applicants boundary

# **SHADOW STUDY - DECEMBER** (Sunrise at 5.55am)

# **21 DECEMBER - 7.00AM**

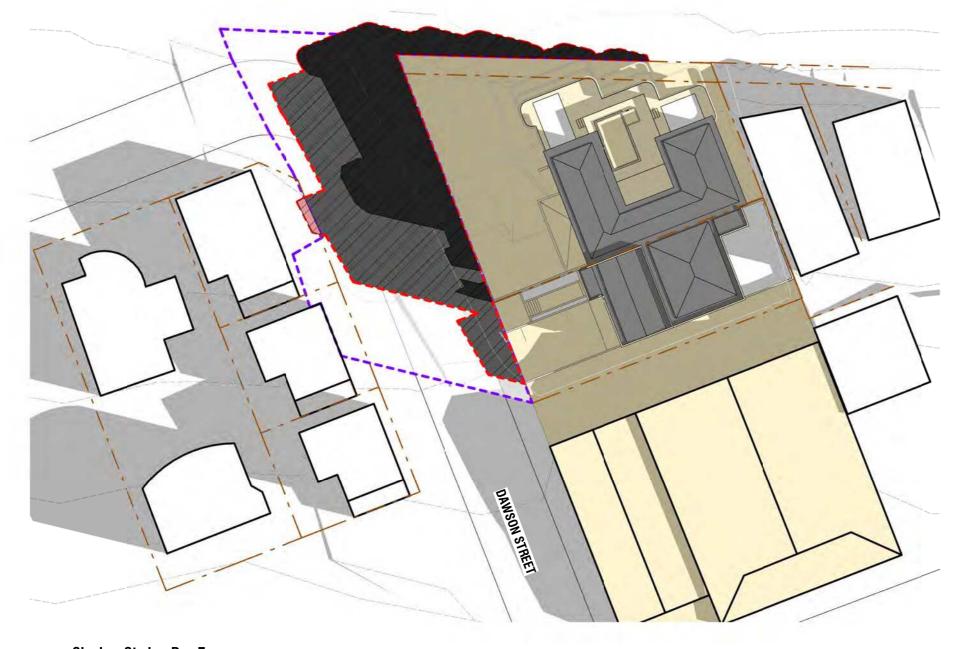

Shadow Study - Dec 7am

Scale 1:500 (A3)

NB: ALL EXISTING NEIGHBOURING BUILDINGS; SIZE/SHAPE/HEIGHT/LOCATION/LEVELS ETC. ARE SHOWN APPROXIMATE ONLY AND ARE NOT BASED ON SURVEYED INFORMATION

ALL SHADOWS SHOWN ARE APPROXIMATE ONLY

Date 29.03.2021 Description RC RFI

1-3 Dawson Street

FEBRUARY | 2021

print date 29/03/21 02:32 PM

**team**architects

# **SHADOW STUDY - DECEMBER**

(Sunrise at 5.55am)


# **21 DECEMBER - 8.00AM**



Shadow Study - Dec 8am

Scale 1:500 (A3)



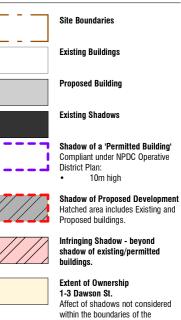

applicants boundary

NB: ALL EXISTING NEIGHBOURING BUILDINGS; SIZE/SHAPE/HEIGHT/LOCATION/LEVELS ETC. ARE SHOWN APPROXIMATE ONLY AND ARE NOT BASED ON SURVEYED INFORMATION

ALL SHADOWS SHOWN ARE APPROXIMATE ONLY

Date Description 29.03.2021 RC RFI

1-3 Dawson Street


**team**architects

FEBRUARY | 2021 6592 As indicated SK4.11 1 Shadow Study - December 8.00am

print date 29/03/21 02:32 PM

(Sunrise at 5.55am)


#### **21 DECEMBER - 9.00AM**

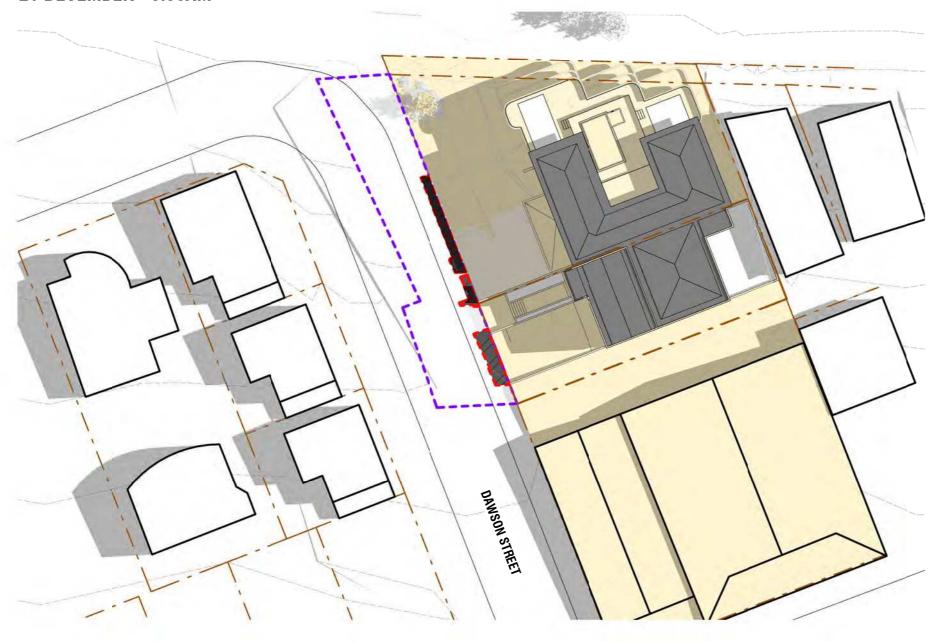

Shadow Study - Dec 9am

Scale 1 : 500 (A3)

#### **Shading Diagrams Key**

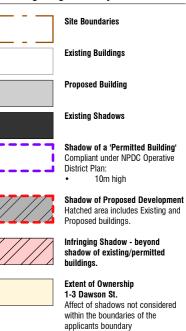

NB: ALL EXISTING NEIGHBOURING BUILDINGS; SIZE/SHAPE/HEIGHT/LOCATION/LEVELS ETC. ARE SHOWN APPROXIMATE ONLY AND ARE NOT BASED ON SURVEYED INFORMATION

ALL SHADOWS SHOWN ARE APPROXIMATE ONLY

RevDateDescription129.03.2021RC RFI

1-3 Dawson Street
New Plymouth

FEBRUARY | 2021

| job no. | a3 scale | drawing no | rev | drawing title | SK4.12 | 1 | Shadow Study - December 9.00am

print date 29/03/21 02:32 PM

**BOON** teamarchitects

## MARCH (Sunset at 7.30pm)


## **SUNSET SHADOW STUDY -** 21 MARCH

- 5.00PM
- 6.00PM
- 7.00PM

## **SHADOW STUDY - MARCH**

(Sunset at 7.30pm)

21 MARCH - 5.00PM

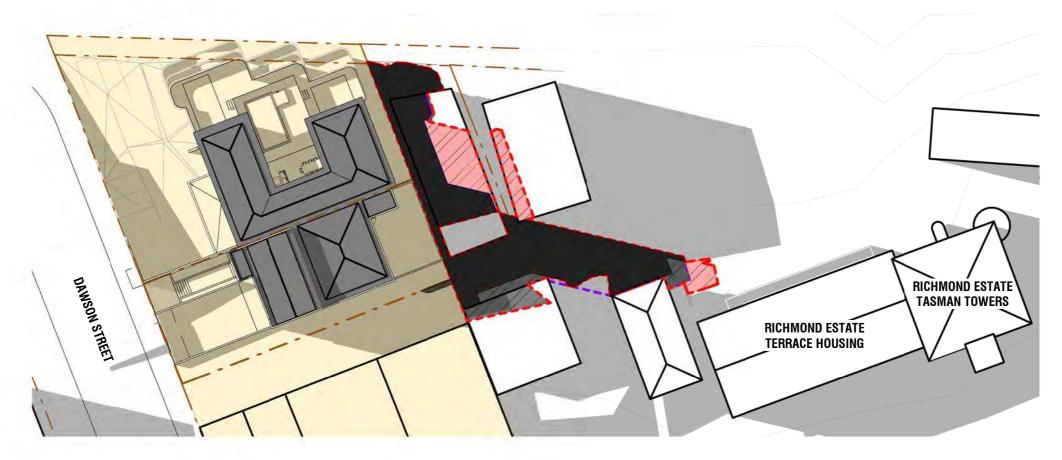

Shadow Study - March 5pm Scale 1:500 (A3)

**Shading Diagrams Key** 

**Site Boundaries** 

**Proposed Building** 

**Existing Shadows** 

**Existing Buildings** 



Shadow of a 'Permitted Building' Compliant under NPDC Operative District Plan:

10m high



**Shadow of Proposed Development** Hatched area includes Existing and Proposed buildings.



Infringing Shadow - beyond shadow of existing/permitted



**Extent of Ownership** 1-3 Dawson St.

Affect of shadows not considered within the boundaries of the applicants boundary

NB: ALL EXISTING NEIGHBOURING BUILDINGS; SIZE/SHAPE/HEIGHT/LOCATION/LEVELS ETC. ARE SHOWN APPROXIMATE ONLY AND ARE NOT BASED ON SURVEYED INFORMATION

ALL SHADOWS SHOWN ARE APPROXIMATE ONLY

Date Description 29.03.2021 RC RFI

1-3 Dawson Street

FEBRUARY | 2021

print date 29/03/21 02:32 PM


**team**architects

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## **SHADOW STUDY - MARCH**

(Sunset at 7.30pm)

21 MARCH - 6.00PM

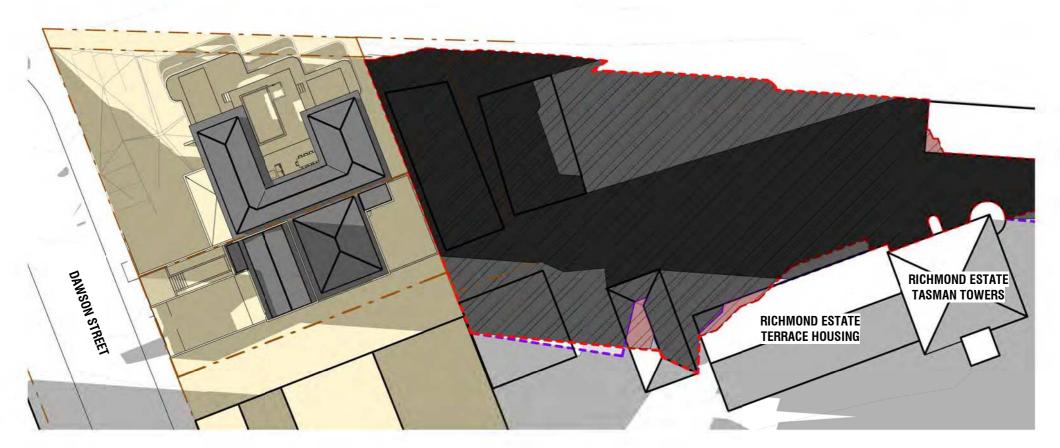

Shadow Study - March 6pm

Scale 1:500 (A3)

**Site Boundaries** 

**Shading Diagrams Key** 

**Existing Buildings** 

**Proposed Building** 

**Existing Shadows** 



Shadow of a 'Permitted Building'

Compliant under NPDC Operative District Plan: 10m high



**Shadow of Proposed Development** Hatched area includes Existing and Proposed buildings.



Infringing Shadow - beyond shadow of existing/permitted



**Extent of Ownership** 1-3 Dawson St.

Affect of shadows not considered within the boundaries of the applicants boundary

NB: ALL EXISTING NEIGHBOURING BUILDINGS; SIZE/SHAPE/HEIGHT/LOCATION/LEVELS ETC. ARE SHOWN APPROXIMATE ONLY AND ARE NOT BASED ON SURVEYED INFORMATION

ALL SHADOWS SHOWN ARE APPROXIMATE ONLY

Date Description 29.03.2021 RC RFI

1-3 Dawson Street

FEBRUARY | 2021

print date 29/03/21 02:32 PM


**team**architects

6592 As indicated SK4.14 1 Shadow Study - March 6pm

#### **SHADOW STUDY - MARCH**

(Sunset at 7.30pm)

21 MARCH - 7.00PM

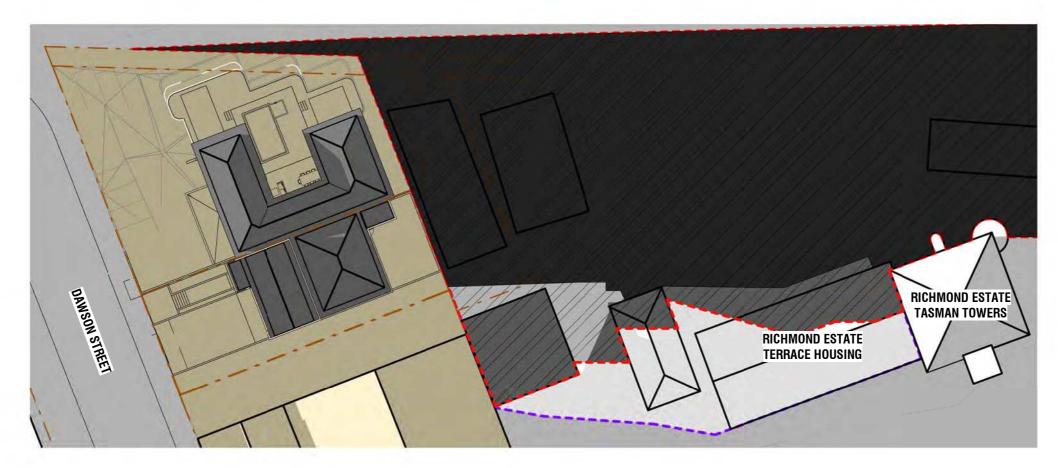

Shadow Study - March 7pm

Scale 1:500 (A3)



**Shading Diagrams Key** 

**Proposed Building** 

**Site Boundaries** 

**Existing Buildings** 



Shadow of a 'Permitted Building' Compliant under NPDC Operative District Plan: 10m high



**Shadow of Proposed Development** Hatched area includes Existing and Proposed buildings.



Infringing Shadow - beyond shadow of existing/permitted



Extent of Ownership 1-3 Dawson St.

Affect of shadows not considered within the boundaries of the applicants boundary

NB: ALL EXISTING NEIGHBOURING BUILDINGS; SIZE/SHAPE/HEIGHT/LOCATION/LEVELS ETC. ARE SHOWN APPROXIMATE ONLY AND ARE NOT BASED ON SURVEYED INFORMATION

ALL SHADOWS SHOWN ARE APPROXIMATE ONLY

Date Description 29.03.2021 RC RFI

1-3 Dawson Street

**team**architects

6592 As indicated

SK4.15

1 Shadow Study - March 7pm

print date 29/03/21 02:33 PM

FEBRUARY | 2021

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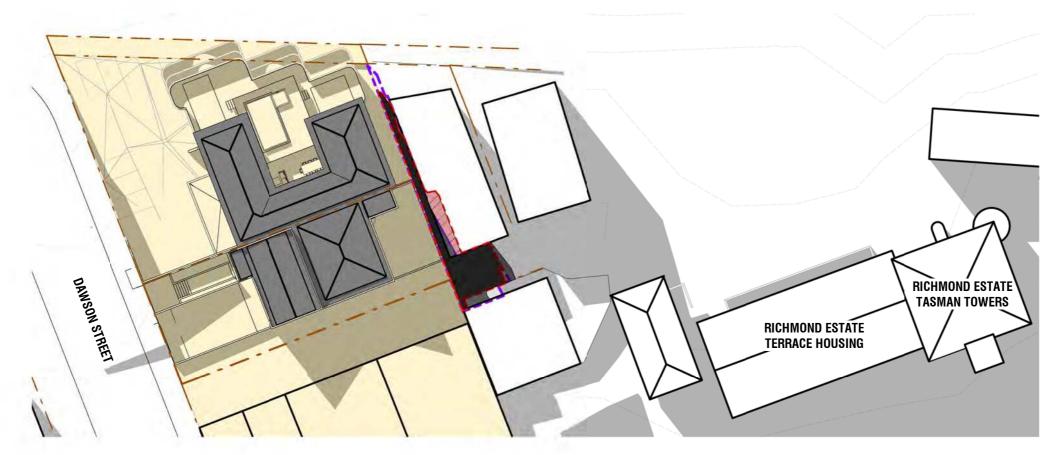
## **SUNSET SHADOW STUDY -** 21 JUNE

- 3.00PM
- 4.00PM
- 5.00PM

### **SHADOW STUDY - JUNE**

(Sunset at 5.10pm)


21 JUNE - 3.00PM



Shadow Study - June 3pm

Scale 1:500 (A3)



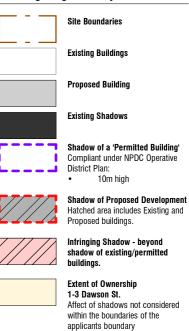

NB: ALL EXISTING NEIGHBOURING BUILDINGS; SIZE/SHAPE/HEIGHT/LOCATION/LEVELS ETC. ARE SHOWN APPROXIMATE ONLY AND ARE NOT BASED ON SURVEYED INFORMATION

ALL SHADOWS SHOWN ARE APPROXIMATE ONLY

RevDateDescription129.03.2021RC RFI

1-3 Dawson Street
New Plymouth

New Plymouth
SOURCE CONSENT
FEBRUARY 2021

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| ob no. | a3 scale | As indicated | drawing no | SK4.16 | Shadow Study - June 3pm


print date 29/03/21 02:33 PM

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### **SHADOW STUDY - JUNE**


(Sunset at 5.10pm)

21 JUNE - 4.00PM

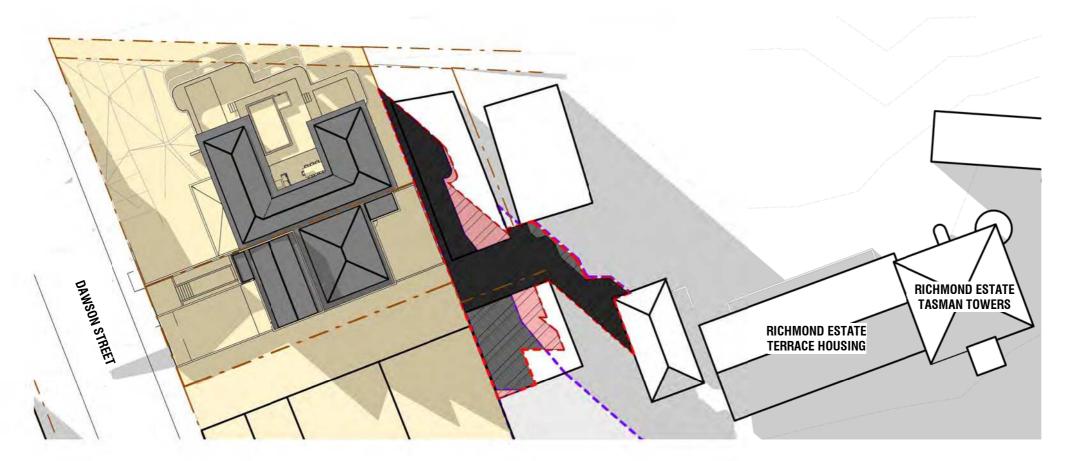

Shadow Study - June 4pm Scale 1:500 (A3)



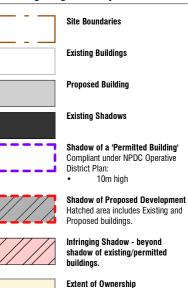

1-3 Dawson St.

Affect of shadows not considered within the boundaries of the applicants boundary

NB: ALL EXISTING NEIGHBOURING BUILDINGS; SIZE/SHAPE/HEIGHT/LOCATION/LEVELS ETC. ARE SHOWN APPROXIMATE ONLY AND ARE NOT BASED ON SURVEYED INFORMATION

ALL SHADOWS SHOWN ARE APPROXIMATE ONLY

RevDateDescription129.03.2021RC RFI

1-3 Dawson Street
New Plymouth

New Plymouth
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FEBRUARY 2021

Teamarchitects

| Job no. | As indicated | Grawing no | Grawing title | Sk4.17 | Shadow Study - June 4pm | print date | 29/03/21 02:33 PM

### **SHADOW STUDY - JUNE**


(Sunset at 5.10pm)

21 JUNE - 5.00PM



Shadow Study - June 5pm Scale 1 : 500 (A3)



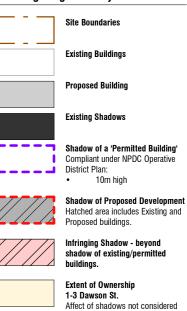

applicants boundary

within the boundaries of the

NB: ALL EXISTING NEIGHBOURING BUILDINGS; SIZE/SHAPE/HEIGHT/LOCATION/LEVELS ETC. ARE SHOWN APPROXIMATE ONLY AND ARE NOT BASED ON SURVEYED INFORMATION

ALL SHADOWS SHOWN ARE APPROXIMATE ONLY

RevDateDescription129.03.2021RC RFI

1-3 Dawson Street
New Plymouth

New Plymouth
SOURCE CONSENT
FEBRUARY 2021 teamarchitects

| job no. | a3 scale | drawing no | rev | drawing title | SK4.18 | The shadow Study - June 5pm | print date | 29/03/21 02:33 PM

# SEPTEMBER

(Sunset at 6.20pm)


## **SUNSET SHADOW STUDY -** 21 SEPTEMBER

- 4.00PM
- 5.00PM
- 6.00PM

### **SHADOW STUDY - SEPTEMBER**

(Sunset at 6.20pm)

21 SEPTEMBER - 4.00PM

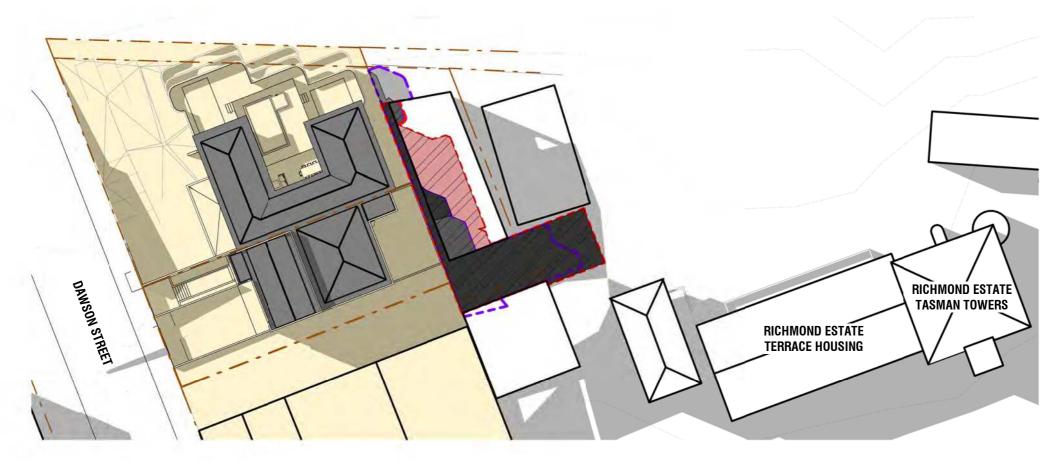

Shadow Study - Sept 4pm Scale 1 : 500 (A3)







Shadow of Proposed Development Hatched area includes Existing and Proposed buildings.



Infringing Shadow - beyond shadow of existing/permitted buildings.



Extent of Ownership
1-3 Dawson St.
Affect of shadows not consider

Affect of shadows not considered within the boundaries of the applicants boundary

NB: ALL EXISTING NEIGHBOURING BUILDINGS; SIZE/SHAPE/HEIGHT/LOCATION/LEVELS ETC. ARE SHOWN APPROXIMATE ONLY AND ARE NOT BASED ON SURVEYED INFORMATION

ALL SHADOWS SHOWN ARE APPROXIMATE ONLY

RevDateDescription129.03.2021RC RFI

1-3 Dawson Street
New Plymouth

teamarchitects

| ob no. | a3 scale | As indicated | drawing no | SK4.19 | Shadow Study - September 4pm


print date 29/03/21 02:33 PM

FEBRUARY | 2021

## **SHADOW STUDY - SEPTEMBER**

(Sunset at 6.20pm)

**21 SEPTEMBER - 5.00PM** 

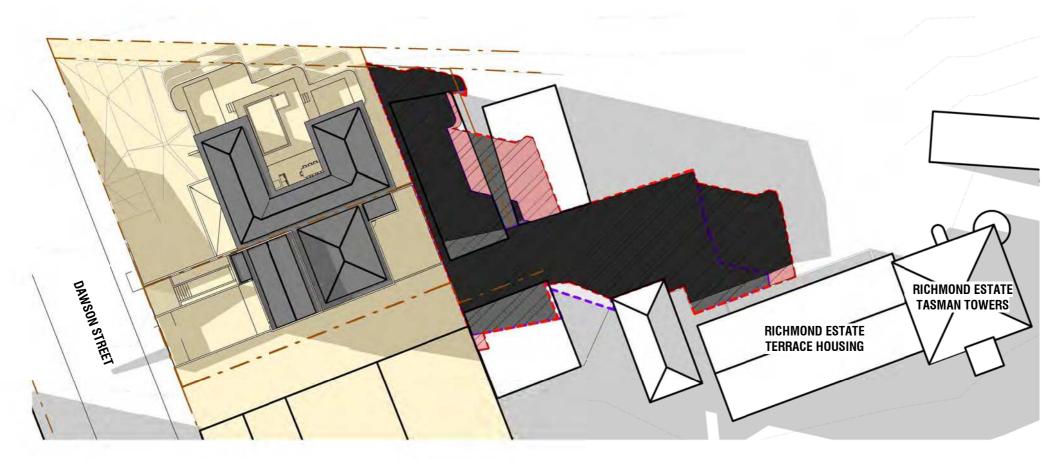

Shadow Study - Sept 5pm Scale 1:500 (A3)





**Proposed Building** 



**Existing Shadows** 



Shadow of a 'Permitted Building' Compliant under NPDC Operative





**Shadow of Proposed Development** Hatched area includes Existing and Proposed buildings.



Infringing Shadow - beyond shadow of existing/permitted



**Extent of Ownership** 1-3 Dawson St.

Affect of shadows not considered within the boundaries of the applicants boundary

NB: ALL EXISTING NEIGHBOURING BUILDINGS; SIZE/SHAPE/HEIGHT/LOCATION/LEVELS ETC. ARE SHOWN APPROXIMATE ONLY AND ARE NOT BASED ON SURVEYED INFORMATION

ALL SHADOWS SHOWN ARE APPROXIMATE ONLY

Date Description 29.03.2021 RC RFI

6592 As indicated

1-3 Dawson Street

**team**architects FEBRUARY | 2021

1 Shadow Study - September 5pm

print date 29/03/21 02:33 PM

SK4.20

### **SHADOW STUDY - SEPTEMBER**

(Sunset at 6.20pm)


21 SEPTEMBER - 6.00PM



Shadow Study - Sept 6pm Scale 1:500 (A3)





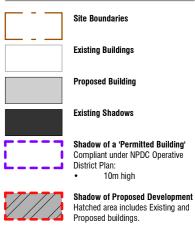



Infringing Shadow - beyond shadow of existing/permitted



**Extent of Ownership** 1-3 Dawson St. Affect of shadows not considered within the boundaries of the applicants boundary

NB: ALL EXISTING NEIGHBOURING BUILDINGS; SIZE/SHAPE/HEIGHT/LOCATION/LEVELS ETC. ARE SHOWN APPROXIMATE ONLY AND ARE NOT BASED ON SURVEYED INFORMATION

ALL SHADOWS SHOWN ARE APPROXIMATE ONLY

Date Description 29.03.2021 RC RFI

1-3 Dawson Street FEBRUARY | 2021

print date 29/03/21 02:33 PM

**team**architects

6592 As indicated SK4.21 1 Shadow Study - September 6pm

# DECEMBER


(Sunset at 8.50pm)

## **SUNSET SHADOW STUDY -** 21 DECEMBER

- 6.00PM
- 7.00PM
- 8.00PM

(Sunset at 8.50pm)


**21 DECEMBER - 6.00PM** 

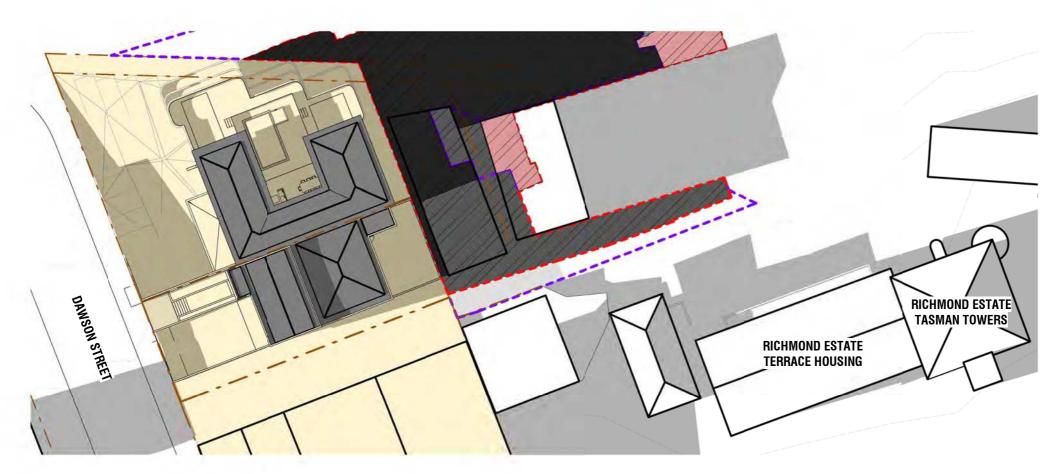

Shadow Study - sunset Dec 6pm

Scale 1:500 (A3)



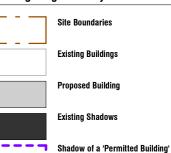



Compliant under NPDC Operative District Plan: 10m high



Infringing Shadow - beyond shadow of existing/permitted



**Extent of Ownership** 1-3 Dawson St.

Affect of shadows not considered within the boundaries of the applicants boundary

NB: ALL EXISTING NEIGHBOURING BUILDINGS; SIZE/SHAPE/HEIGHT/LOCATION/LEVELS ETC. ARE SHOWN APPROXIMATE ONLY AND ARE NOT BASED ON SURVEYED INFORMATION

ALL SHADOWS SHOWN ARE APPROXIMATE ONLY

Date Description 29.03.2021 RC RFI

6592 As indicated

1-3 Dawson Street

FEBRUARY | 2021

1 Shadow Study - December 6pm


print date 29/03/21 02:33 PM



SK4.22

(Sunset at 8.50pm)

**21 DECEMBER - 7.00PM** 

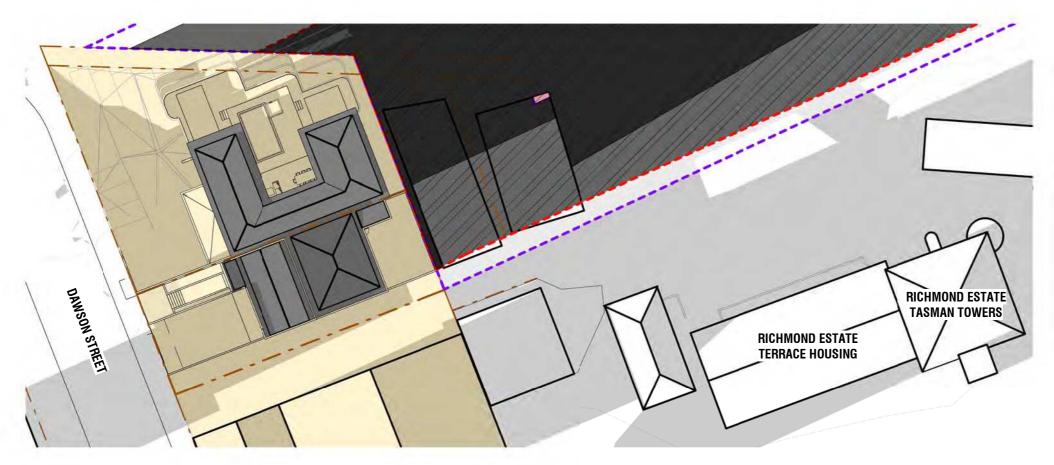

Shadow Study - sunset Dec 7pm

Scale 1:500 (A3)

 Rev
 Date
 Description

 1
 29.03.2021
 RC RFI



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29/03/21 02:34 PM A / 131 Courtenay St, New Plymouth 4310, New Zealand P / 06 757 3200 E / office@boon.co.nz W / boon.co.nz

6592 As indicated SK4.23 1 Shadow Study - December 7pm



Existing Buildings

Proposed Building

Existing Shadows

Shadow of a 'Permitted Building'
Compliant under NPDC Operative
District Plan:
10m high

Shadow of Proposed Development
Hatched area includes Existing and
Proposed buildings.

Infringing Shadow - beyond
shadow of existing/permitted

Extent of Ownership 1-3 Dawson St.

1-3 Dawson St.


Affect of shadows not considered within the boundaries of the applicants boundary

NB: ALL EXISTING NEIGHBOURING BUILDINGS; SIZE/SHAPE/HEIGHT/LOCATION/LEVELS ETC. ARE SHOWN APPROXIMATE ONLY AND ARE NOT BASED ON SURVEYED INFORMATION

ALL SHADOWS SHOWN ARE APPROXIMATE ONLY

(Sunset at 8.50pm)

**21 DECEMBER - 8.00PM** 

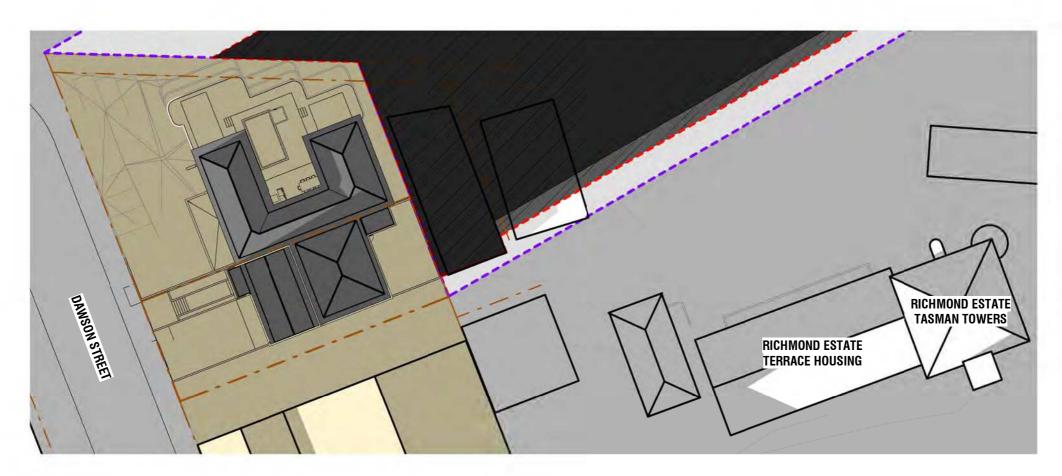

Shadow Study - sunset Dec 8pm

Scale 1 : 500 (A3)

RevDateDescription129.03.2021RC RFI

6592 As indicated

1-3 Dawson Street


New Plymouth

RESOURCE CONSENT

FEBRUARY | 2021

print date 29/03/21 02:34 PM N

#### **Shading Diagrams Key**

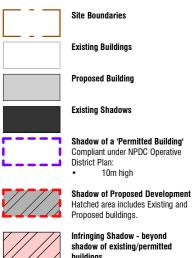



Extent of Ownership
1-3 Dawson St.
Affect of shadows not consider


Affect of shadows not considered within the boundaries of the applicants boundary


NB: ALL EXISTING NEIGHBOURING BUILDINGS; SIZE/SHAPE/HEIGHT/LOCATION/LEVELS ETC. ARE SHOWN APPROXIMATE ONLY AND ARE NOT BASED ON SURVEYED INFORMATION

ALL SHADOWS SHOWN ARE APPROXIMATE ONLY

1 Shadow Study - December 8pm

SK4.24

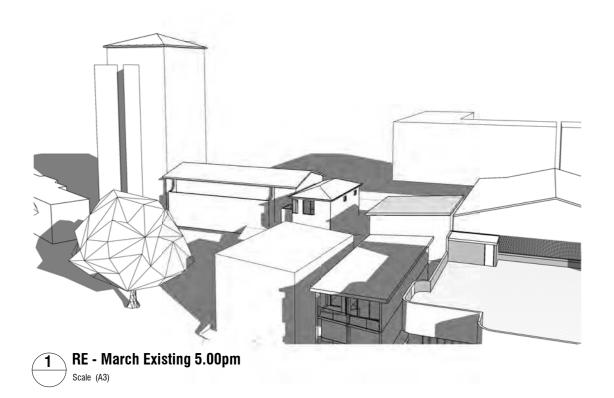

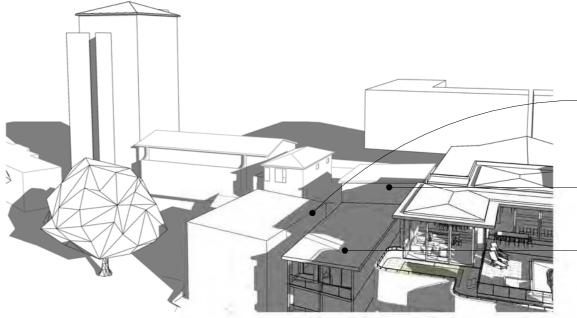

MARCH 21 5.00PM AND 5.30PM

#### SUNSET TIME: 7.34pm

NB: ALL EXISTING NEIGHBOURING BUILDINGS; SIZE/SHAPE/HEIGHT/LOCATION/LEVELS ETC. ARE SHOWN APPROXIMATE ONLY AND ARE NOT BASED ON SURVEYED INFORMATION

122B St Aubyn Street Additional shading to Western elevation, Northern elevation (from balustrade) and building roof top in March.

Approx. 1.5 hours of the day affected by additional shading.


122 St Aubyn Street Additional shading to Northern elevation in March. Approx. 4 hours of the day affected by additional shading.

122A St Aubyn Street
Additional shading limited to Western elevation and building roof top in March.

 $\dot{\text{Approx.}}$  3 hours of the day affected by additional shading.

RE - March Proposed 5.00pm

Scale (A3)

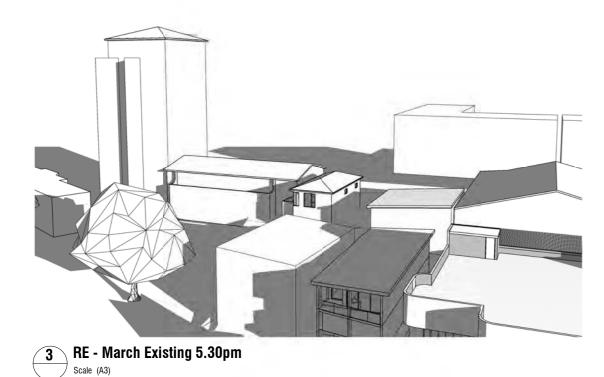

4 RE - March Proposed 5.30pm

**Richmond Apartments** 

Additional shading to Northern elevation in March. Approx. 1.75 hours of the day affected by additional shading.

122B St Aubyn Street Additional shading to Western elevation, Northern elevation (from balustrade) and building roof top in March

Approx. 1.5 hours of the day affected by additional shading.

Example of balustrade extension shading.

#### 122 St Aubyn Street

Additional shading to Northern elevation in March. Approx. 4 hours of the day affected by additional shading.

122A St Aubyn Street Additional shading limited to Western elevation and building roof

Approx. 3 hours of the day affected by additional shading.

Date Description 29.03.2021

RC RFI

Scale (A3)

job no. 6592


1-3 Dawson Street


FEBRUARY | 2021

29/03/21 02:34 PM

**team**architects

SK5.01 1 Sunset Shadow Studies - March

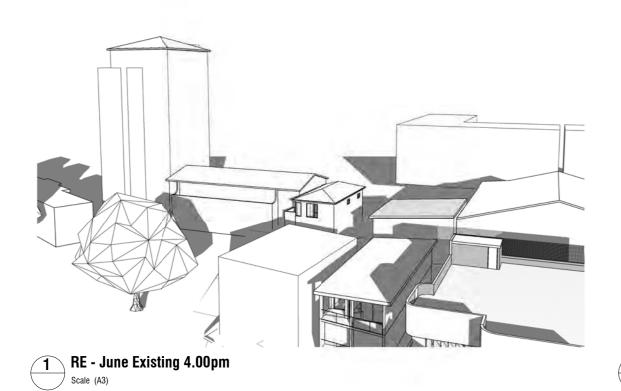

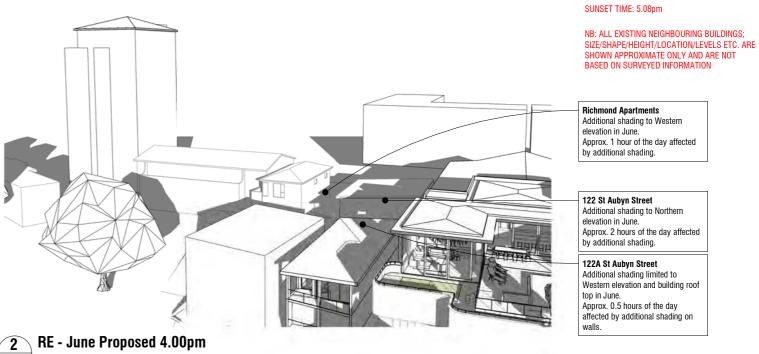

Scale (A3)

Date

29.03.2021

Description

RC RFI

3 RE - June Existing 4.30pm Scale (A3)



1-3 Dawson Street **team**architects FEBRUARY | 2021


print date 29/03/21 02:34 PM


job no. 6592 SK5.02 1 Sunset Shadow Studies - June

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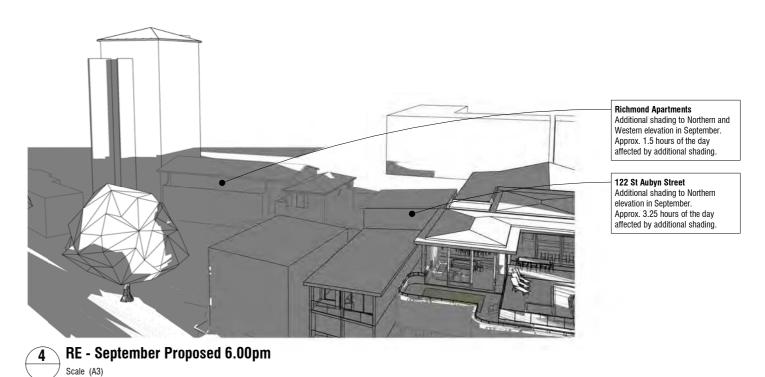
JUNE 21 4.00PM AND 4.30PM





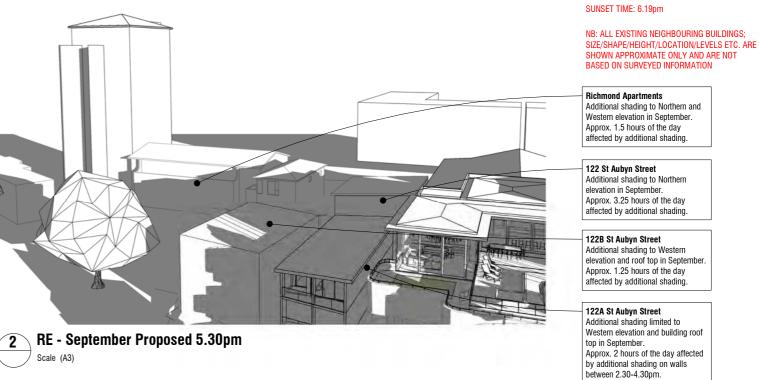

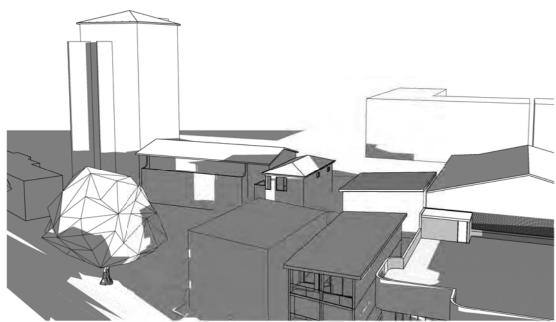



RevDateDescription129.03.2021RC RFI


job no. 6592 1-3 Dawson Street
New Plymouth
RESOURCE CONSENT
FEBRUARY | 2021

Teamarc


SEPTEMBER 21 5.30PM AND 6.00PM

drawing no SK5.03 1 Sunset Shadow Studies - September 29/03/21 02:35 PM

**team**architects

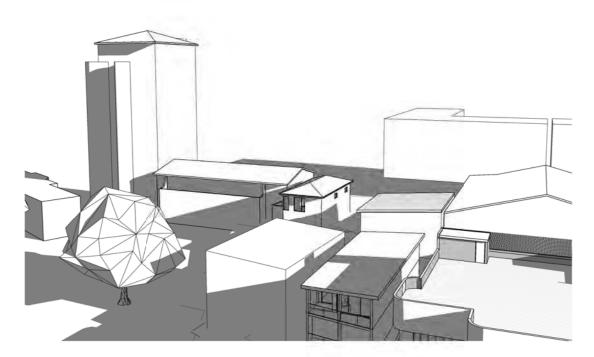

RE - December Existing 6.00pm Scale (A3)

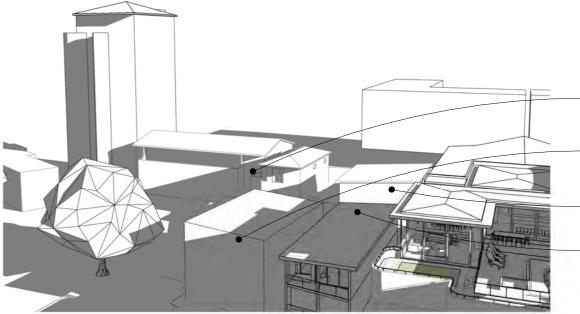

RE - December Proposed 6.00pm Scale (A3)

DECEMBER 21 6.00PM AND 6.30PM

SUNSET TIME: 8.49pm

NB: ALL EXISTING NEIGHBOURING BUILDINGS; SIZE/SHAPE/HEIGHT/LOCATION/LEVELS ETC. ARE SHOWN APPROXIMATE ONLY AND ARE NOT BASED ON SURVEYED INFORMATION

Richmond Apartments
No additional shading to these properties in December

122B St Aubyn Street Additional shading.
Approx. 2 hours of the day affected by additional shading.

122 St Aubyn Street No additional shading to this property in December

122A St Aubyn Street
Additional shading limited to
Western elevation and building roof top in December. Approx. 5.5 hours of the day

affected by additional shading on walls.


122B St Aubyn Street Additional shading to Western elevation and roof top. Approx. 2 hours of the day affected by additional shading.

122A St Aubyn Street Additional shading limited to Western elevation and building roof


Approx. 5.5 hours of the day affected by additional shading on

top in December.

walls.

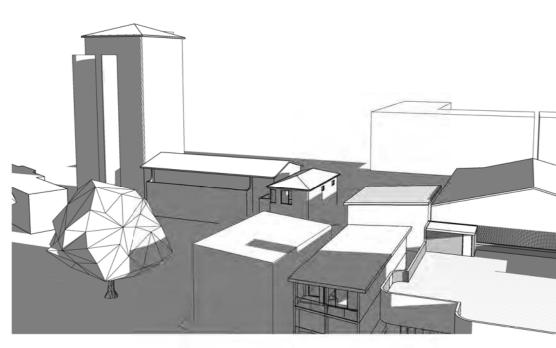

RE - December Existing 6.30pm Scale (A3)

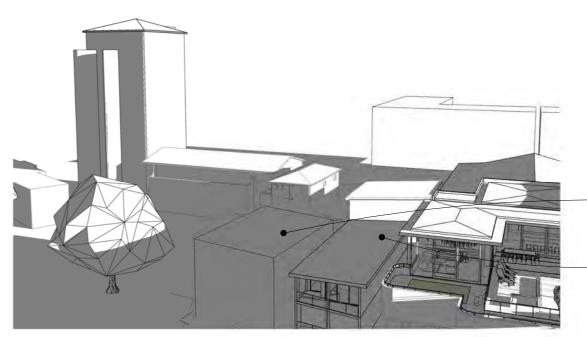

RE - December Proposed 6.30pm

Scale (A3)

job no. 6592

Date Description 29.03.2021 RC RFI


1-3 Dawson Street

SK5.04 1 Sunset Shadow Studies - December

**team**architects FEBRUARY | 2021 29/03/21 02:35 PM

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# Lowest Degree of Additional Shading Mid Degree of Additional Shading Highest Degree of Additional Shading No Additional Shading

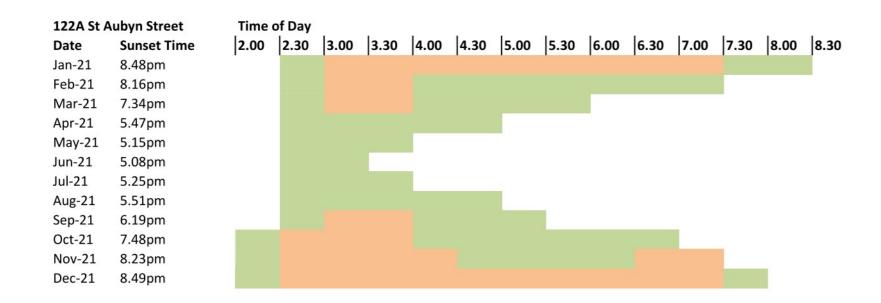

#### 122B St Aubyn Street Time of Day 2.00 | 2.30 | 3.00 | 3.30 | 4.00 | 4.30 | 5.00 | 5.30 | 6.00 | 6.30 | 7.00 | 7.30 | 8.00 | 8.30 **Sunset Time** Date Jan-21 8.48pm Feb-21 8.16pm 7.34pm Mar-21 Apr-21 5.47pm May-21 5.15pm No Effect No Effect Jun-21 5.08pm No Effect Jul-21 5.25pm Aug-21 5.51pm Sep-21 6.19pm Oct-21 7.48pm Nov-21 8.23pm Dec-21 8.49pm

#### 122A St Aubyn Street - Description of Shading Effects

122A St Aubyn Street is the closest property to the proposed development. It is located approximately 4 meters away from the North-Eastern wall of the existing building at 1 Dawson Street, and is already subject to shading effects in the afternoon throughout the year.

The proposed development will affect the Western wall and Roof Top of 122A St Aubyn Street during each month of the year. The additional shading affects will typically be a widening of the existing shading.

122A St Aubyn Street will experience the longes duration of additional shading when compared to the other analysed properties (122, 122B and the Richmond Apartments).

The highest degree of effect will be during the summer months, when the high sun angle will be affected by the additional height of the proposed development.

The lowest degree of effect will be during the winter months, when the low sun angles are already affected by the existing building.

#### 122B St Aubyn Street - Description of Shading Effects

122B St Aubyn Street is approximately 15m to the East of the existing building at 1 Dawson Street, and is already subject to shading effects in the afternoon throughout the year.

The proposed development will have additional shading affects to the upper part of the Western wall and Roof Top in spring, summer and autumn months. It will have a slight affect to the Northern wall in the summer months also.

There will be no additional shading affect to 122B from the proposed development during the winter months.


Rev Date Description
1 29.03.2021 RC RFI



29/03/21 02:27 PM

| job no. | 6592 | a3 scale | drawing no rev drawing title | SK5.05 | 1 Shading Effect Summaries

# Lowest Degree of Additional Shading Mid Degree of Additional Shading Highest Degree of Additional Shading No Additional Shading

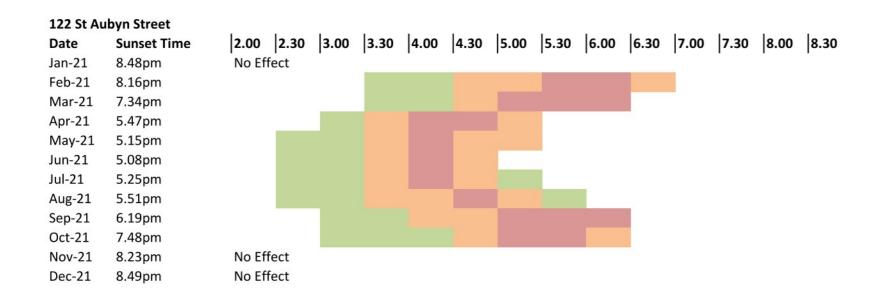

#### Richmond Apartments (Collective)

Date	<b>Sunset Time</b>	2.00	2.30	3.00	3.30	4.00	4.30	5.00	5.30	6.00	6.30	7.00	7.30	8.00	8.30
Jan-21	8.48pm	No Eff	ect												
Feb-21	8.16pm	No Eff	ect												
Mar-21	7.34pm														
Apr-21	5.47pm														
May-21	5.15pm														
Jun-21	5.08pm														
Jul-21	5.25pm														
Aug-21	5.51pm														
Sep-21	6.19pm														
Oct-21	7.48pm	No Eff	ect												
Nov-21	8.23pm	No Eff	ect												
Dec-21	8.49pm	No Eff	ect												

#### 122 St Aubyn Street - Description of Shading Effects

The Richmond Street apartments are located to the South-East of the existing building at 1 Dawson Street, and are already subject to shading effects from the existing building.

The proposed development will have additional shading affects to the Northern and Western walls of the building from March until September.

122 St Aubyn Street will experience the highest degee of additional shading when compared to the other analysed properties (122A, 122B and the Richmond Apartments).

There will be no additional shading affect to 122 from the proposed development during the summer months when the sun angle is high (October through to February).

#### **Richmond Apartments - Description of Shading Effects**

122B St Aubyn Street is approximately 15m to the East of the existing building at 1 Dawson Street, and is already subject to shading effects in the afternoon throughout the year.

The proposed development will have additional shading affects to the upper part of the Western wall and Roof Top in spring, summer and autumn months. It will have a slight affect to the Northern wall in the summer months also.

There will be no additional shading affect to 122B from the proposed development during the winter months.

 Rev
 Date
 Description

 1
 29.03.2021
 RC RFI



| Job no. | 6592 | 33 scale | drawing no | rev | drawing title | SK5.06 | 1 Shading Effect Summaries | 29/03/21 02:27 PM